

USE OF CITY OF FERNDALE DIGITAL DATA IMPLIES THE USER'S AGREEMENT WITH THE FOLLOWING STATEMENT:


The City of Ferndale endeavors to provide accurate digital project information. However, the City of Ferndale disclaims any warranty of merchantability or warranty of fitness of this data for any particular purpose, either express or implied. No representation or warranty is made concerning the accuracy, currency, completeness or quality of data. Any user of this data assumes all responsibility for use thereof, and further agrees to hold the City of Ferndale harmless from and against any damage, loss, or liability arising from any use of this data.

This digital information is provided for the user's convenience as a supplement only and as such it does not replace official methods of disseminating bid information. The City of Ferndale disclaims any and all liability arising from inaccuracy or incompleteness of any provided information.

CENTENNIAL BIVERWALK

CITY OF FERNDALE

VICINITY MAP

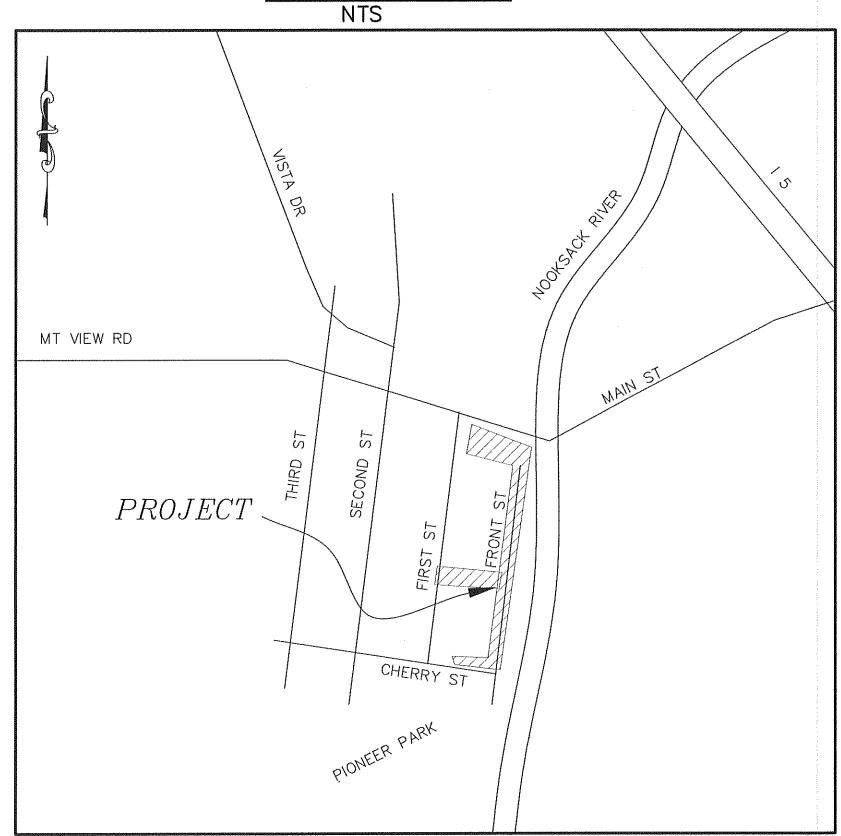


SHEET INDEX

- COVER SHEET
- CHERRY STREET IMPROVEMENTS
- C3.) FRONT STREET IMPROVEMENTS
- C4.) FRONT STREET IMPROVEMENTS
- C5.) MAPLE STREET IMPROVEMENTS
- EROSION CONTROL PLAN
- TYPICAL CROSS SECTIONS
- C8.) DETAILS AND GENERAL NOTES
- L1-L13) LANDSCAPE PLANS
- FL-01) FOUNTAIN LAYOUT
- FD-01) FOUNTAIN DETAILS
- I1-I7) IRRIGATION PLANS
- E1) ELECTRICAL PLAN SOUTH
- E2) ELECTRICAL PLAN NORTH
- E3) ELECTRICAL DETAILS
- C1) RIVER WALK PLACE PLANS

I ECEND

	ett till skyling skylin		
— — FM — — FM —	= EX FORCE MAIN	approximation electricalisation estimaturamen escuentration esculsivated escularisation	■ PROP SAWCUT
			= PROP ROCKWALL
FO FO		000000000000	= PROP ROCKWALL
— G G G	= EX GAS MAIN		= PROP STORM DRAIN CATCH BASI
	= EX GAS METER	sp «	= PROP STORM DRAIN
	= EX TELEPHONE LINE	•	= PROP STORM CLEANOUT
	= EX WATER MAIN		= PROP CATCH BASIN TYPE II
∀	= EX FIRE HYDRANT	**************************************	= PROP SANITARY SEWER
) E	= EX WATER METER		= PROP SEWER MANHOLE
\bowtie	= EX WATER VALVE		
		•	- PROP SEWER CLEANOUT
mac	= EX UTILITY POLE		= PROP WATERMAIN
	= EX TELEPHONE PEDESTAL	- ∳-	= PROP HYDRANT
мвО	= EX MAIL BOX		= PROP WATER METER
Д	= EX SIGN	нχ	= PROP WATER VALVE
\odot	= EX TREE		= PROP REPAIR COUPLER
(= EX GUY WIRE		= PROP SIDEWALK
\$ 	= EX STREET LIGHT		= PROP JBOX
P	= EX POWER VAULT	CANCEL MINISTER MARKET AND AND ADMINISTRATION ADMINISTRA	= PROP CONDUIT
	= EX JBOX		
ssss-	= EX SANITARY SEWER		
\bigcirc	= EX SEWER MANHOLE		
0	= EX SEWER CLEANOUT		
	= EX STORM DRAIN		
Ō	= EX STORM CLEANOUT		
р			
	= EX SD CATCH BASIN		
XXX	= EX FENCE		
<u> </u>	= EX DITCH CL		
	= EX CULVERT		
	= EX EDGE OF PAVEMENT		
TBTB -	= EX TOP OF BANK		
	= EX POWER LINE		
	= EX TOE OF BANK		
MADERIAL MAD	=EX RIGHT OF WAY		
	=EX CONCRETE		A. I.
***************************************	=EX FLOWLINE		OF WASHING
	=EX GRADEBREAK		TE AM DEL
0 0 0 0	=EX GUARDRAIL		- (Landing
			14325
	=EX GRAVEL		PESSION THE THE
	=EX ROAD CL		OVAL DE LA CONTRACTOR D
	=EX BLDG		EXPIRES JUNE 15, 2008

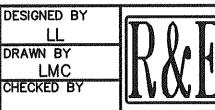

REICHHARDT & EBE ENGINEERING, INC.


PO Box 978 423 Front St., Ste 201 Ph (360) 354-3687 Lynden, Washington 98264 Fax (360) 354-0407 NO. DATE


REVISION


CITY OF FERNDALE 2095 MAIN STREET FERNDALE, WA 98248


CENTENNIAL RIVERWALK COVER SHEET


JOB# / DWG	SHIPPOOCOCIA HARON MADOCA MADO	DATE
05012	SP1	5-4-07
SCALE		SHEET
H:N/A	v: N / A	C1 of C8

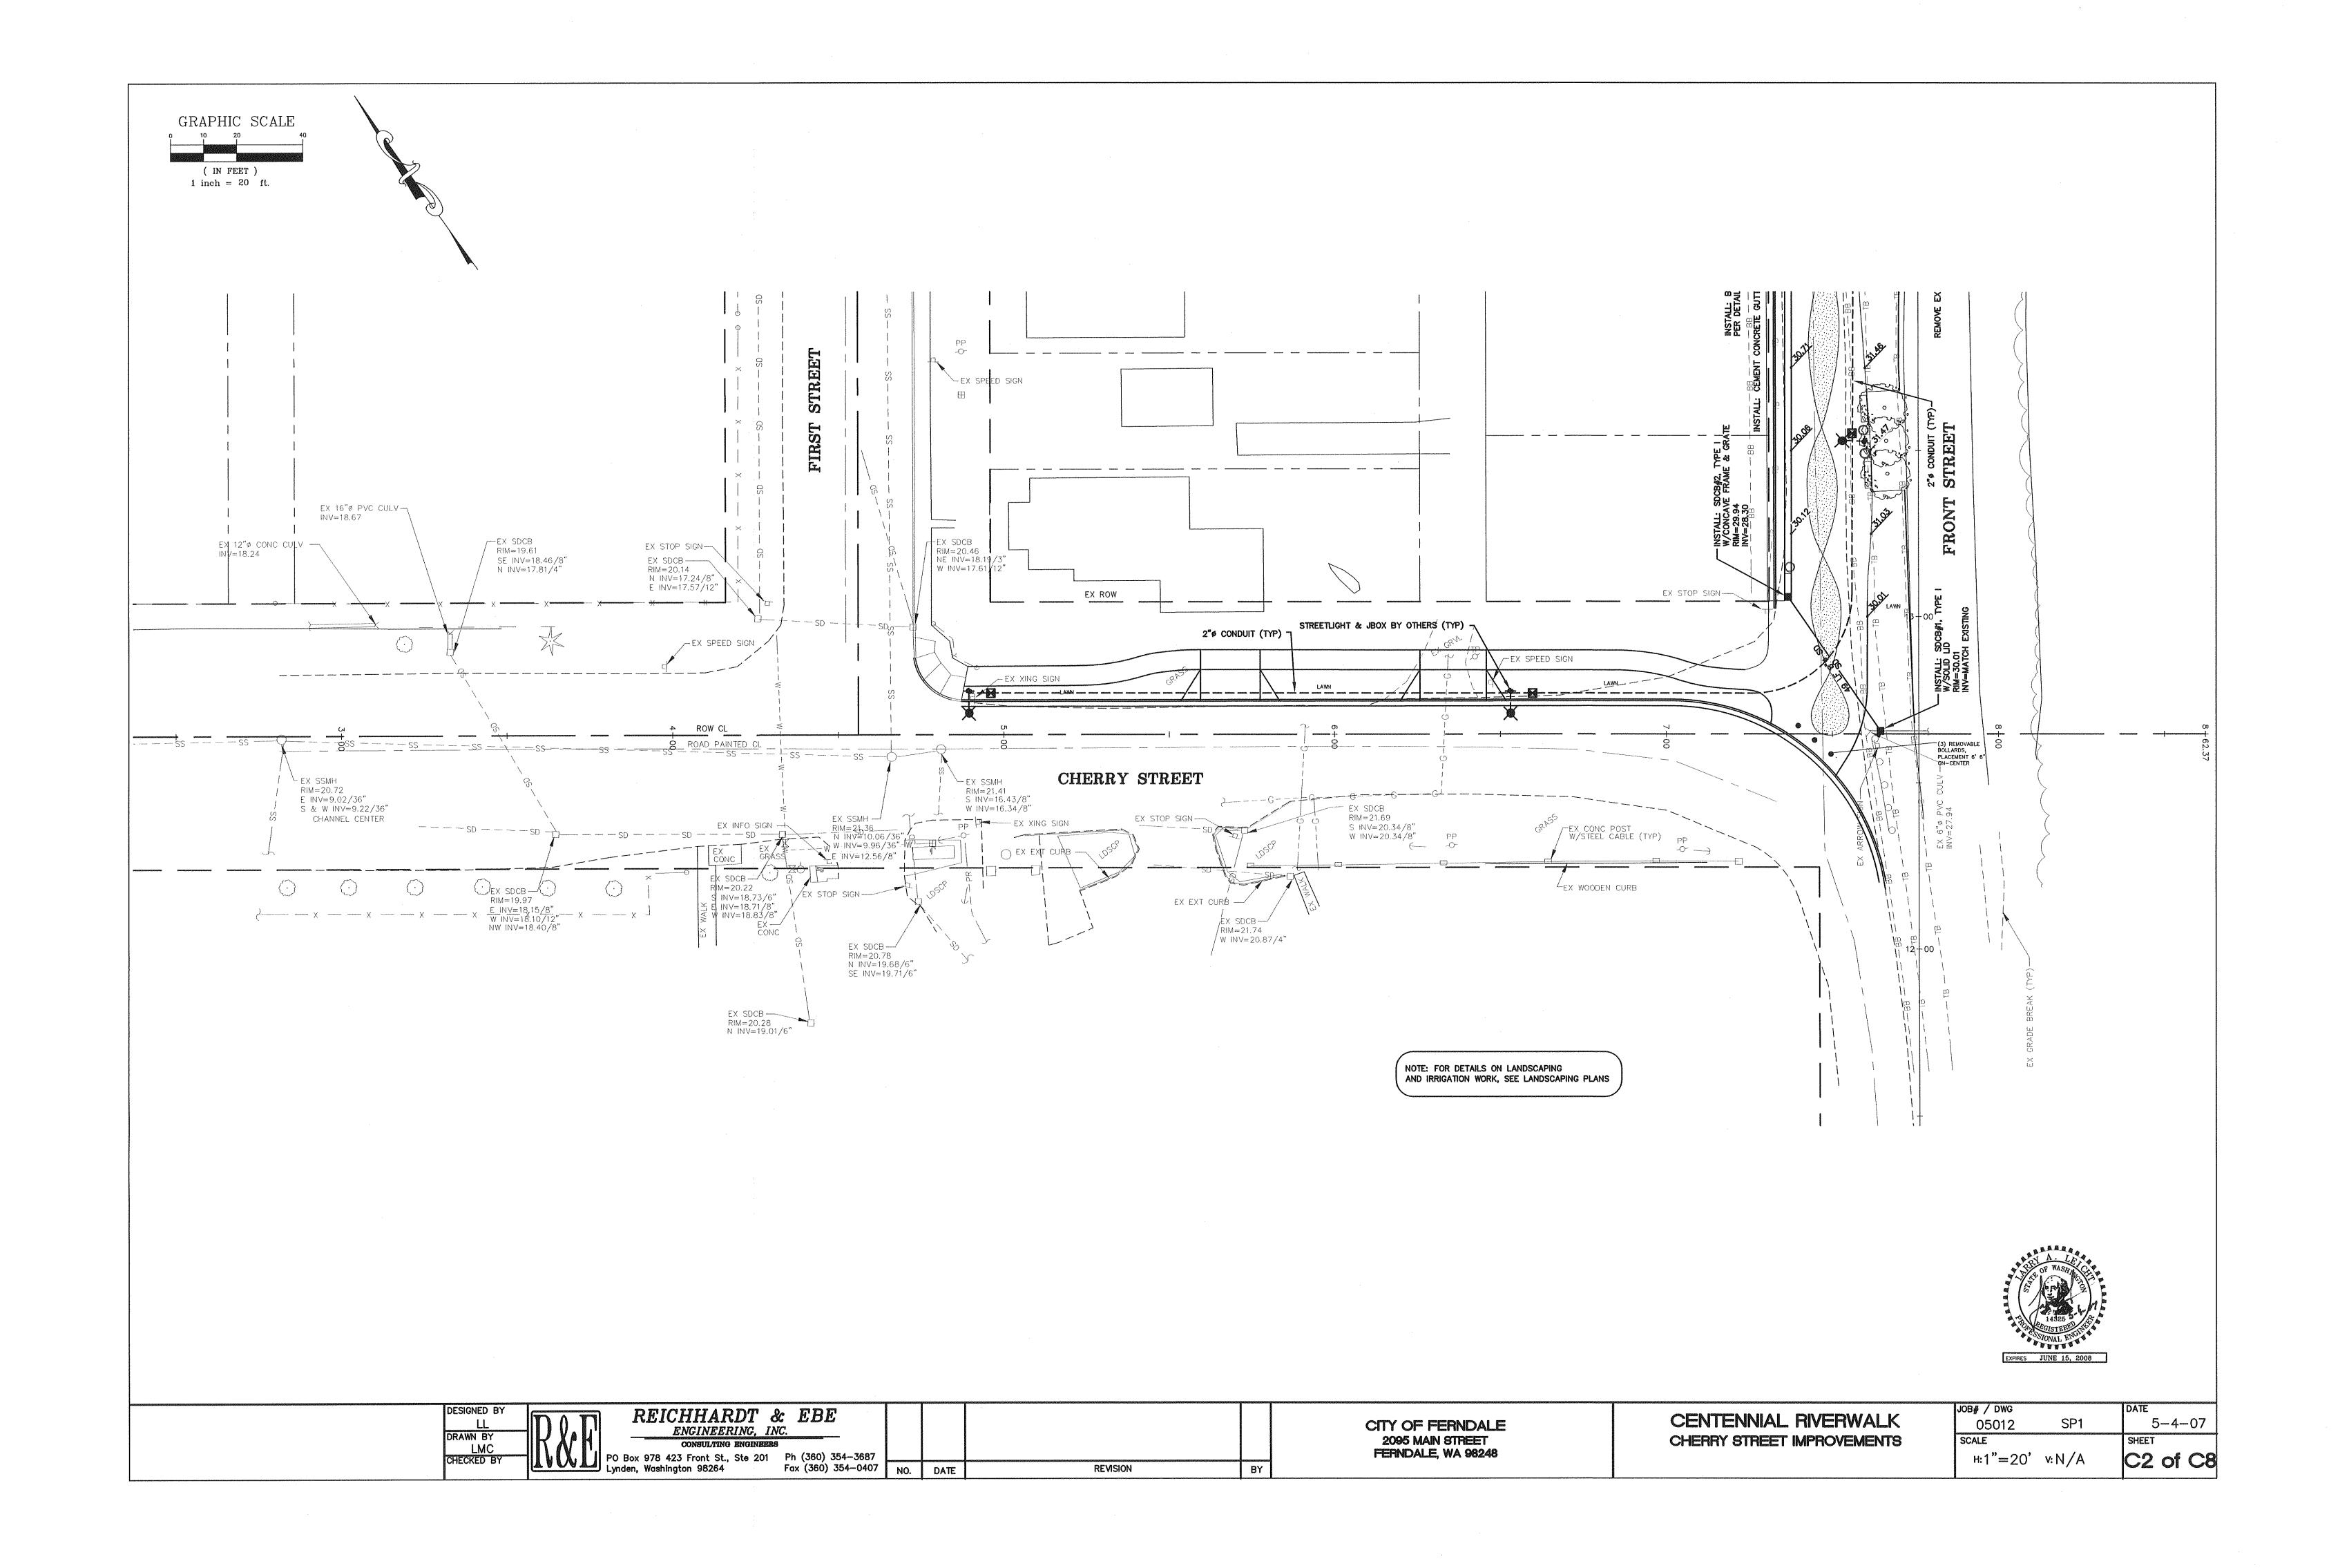


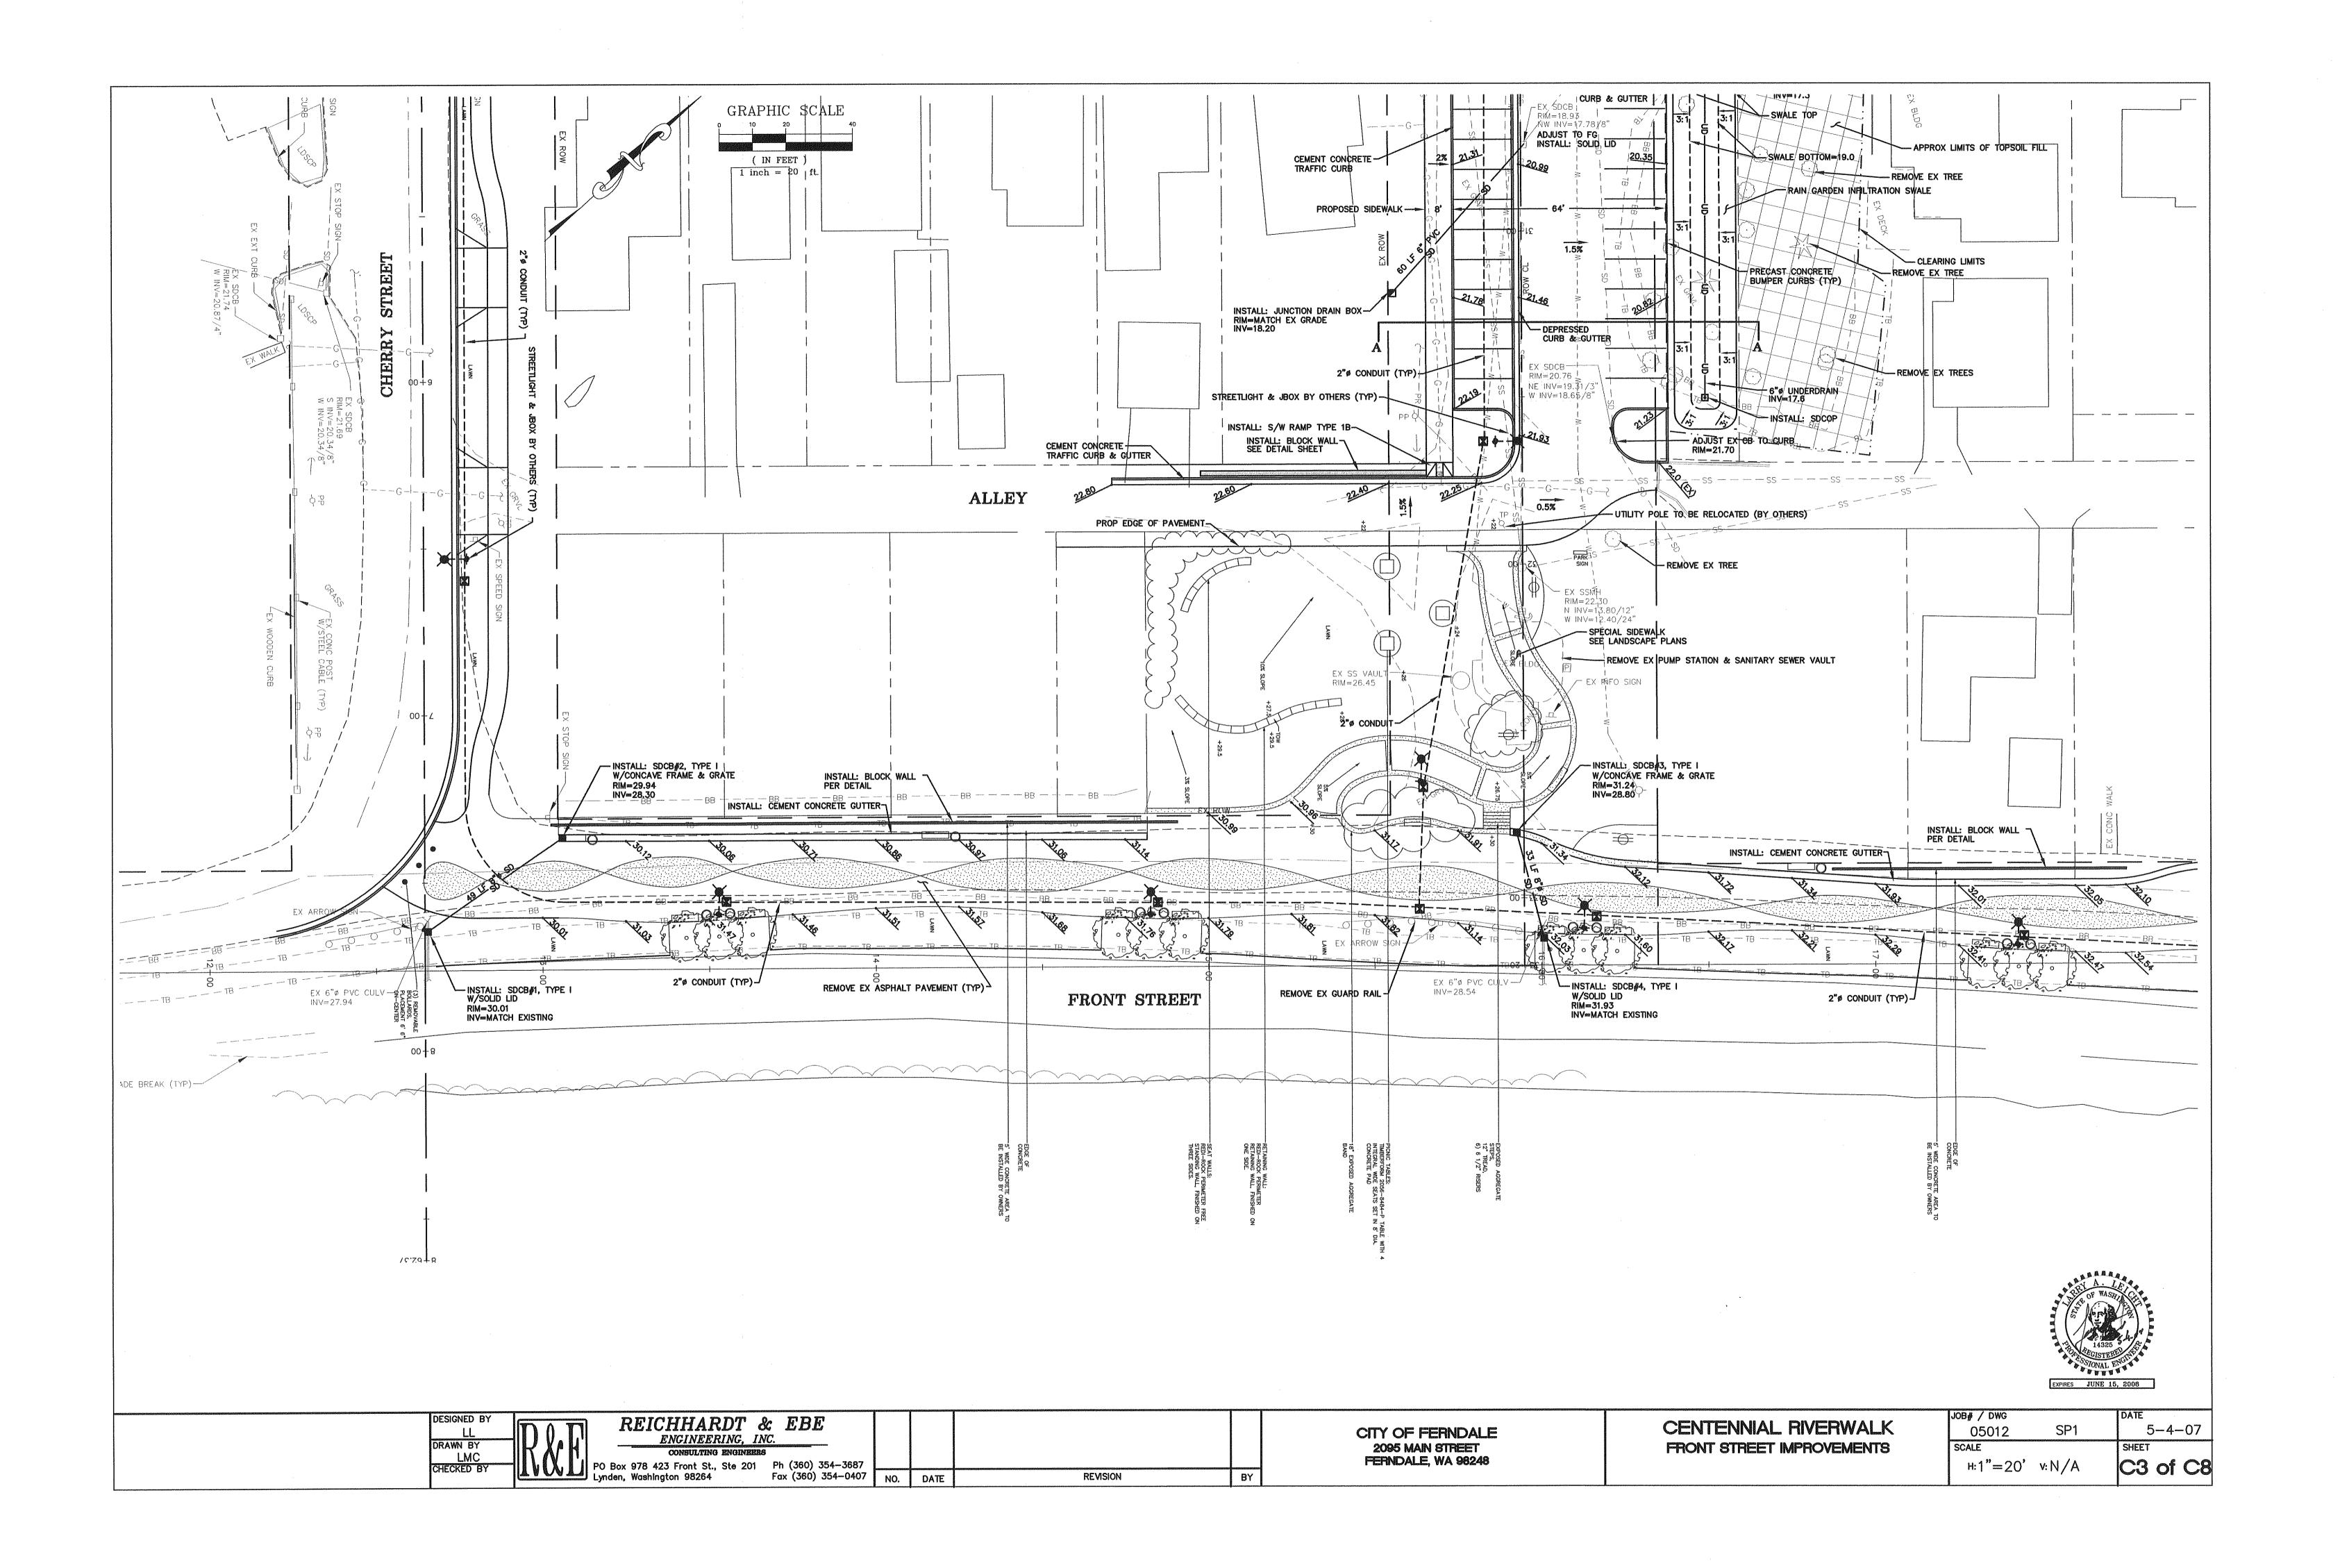


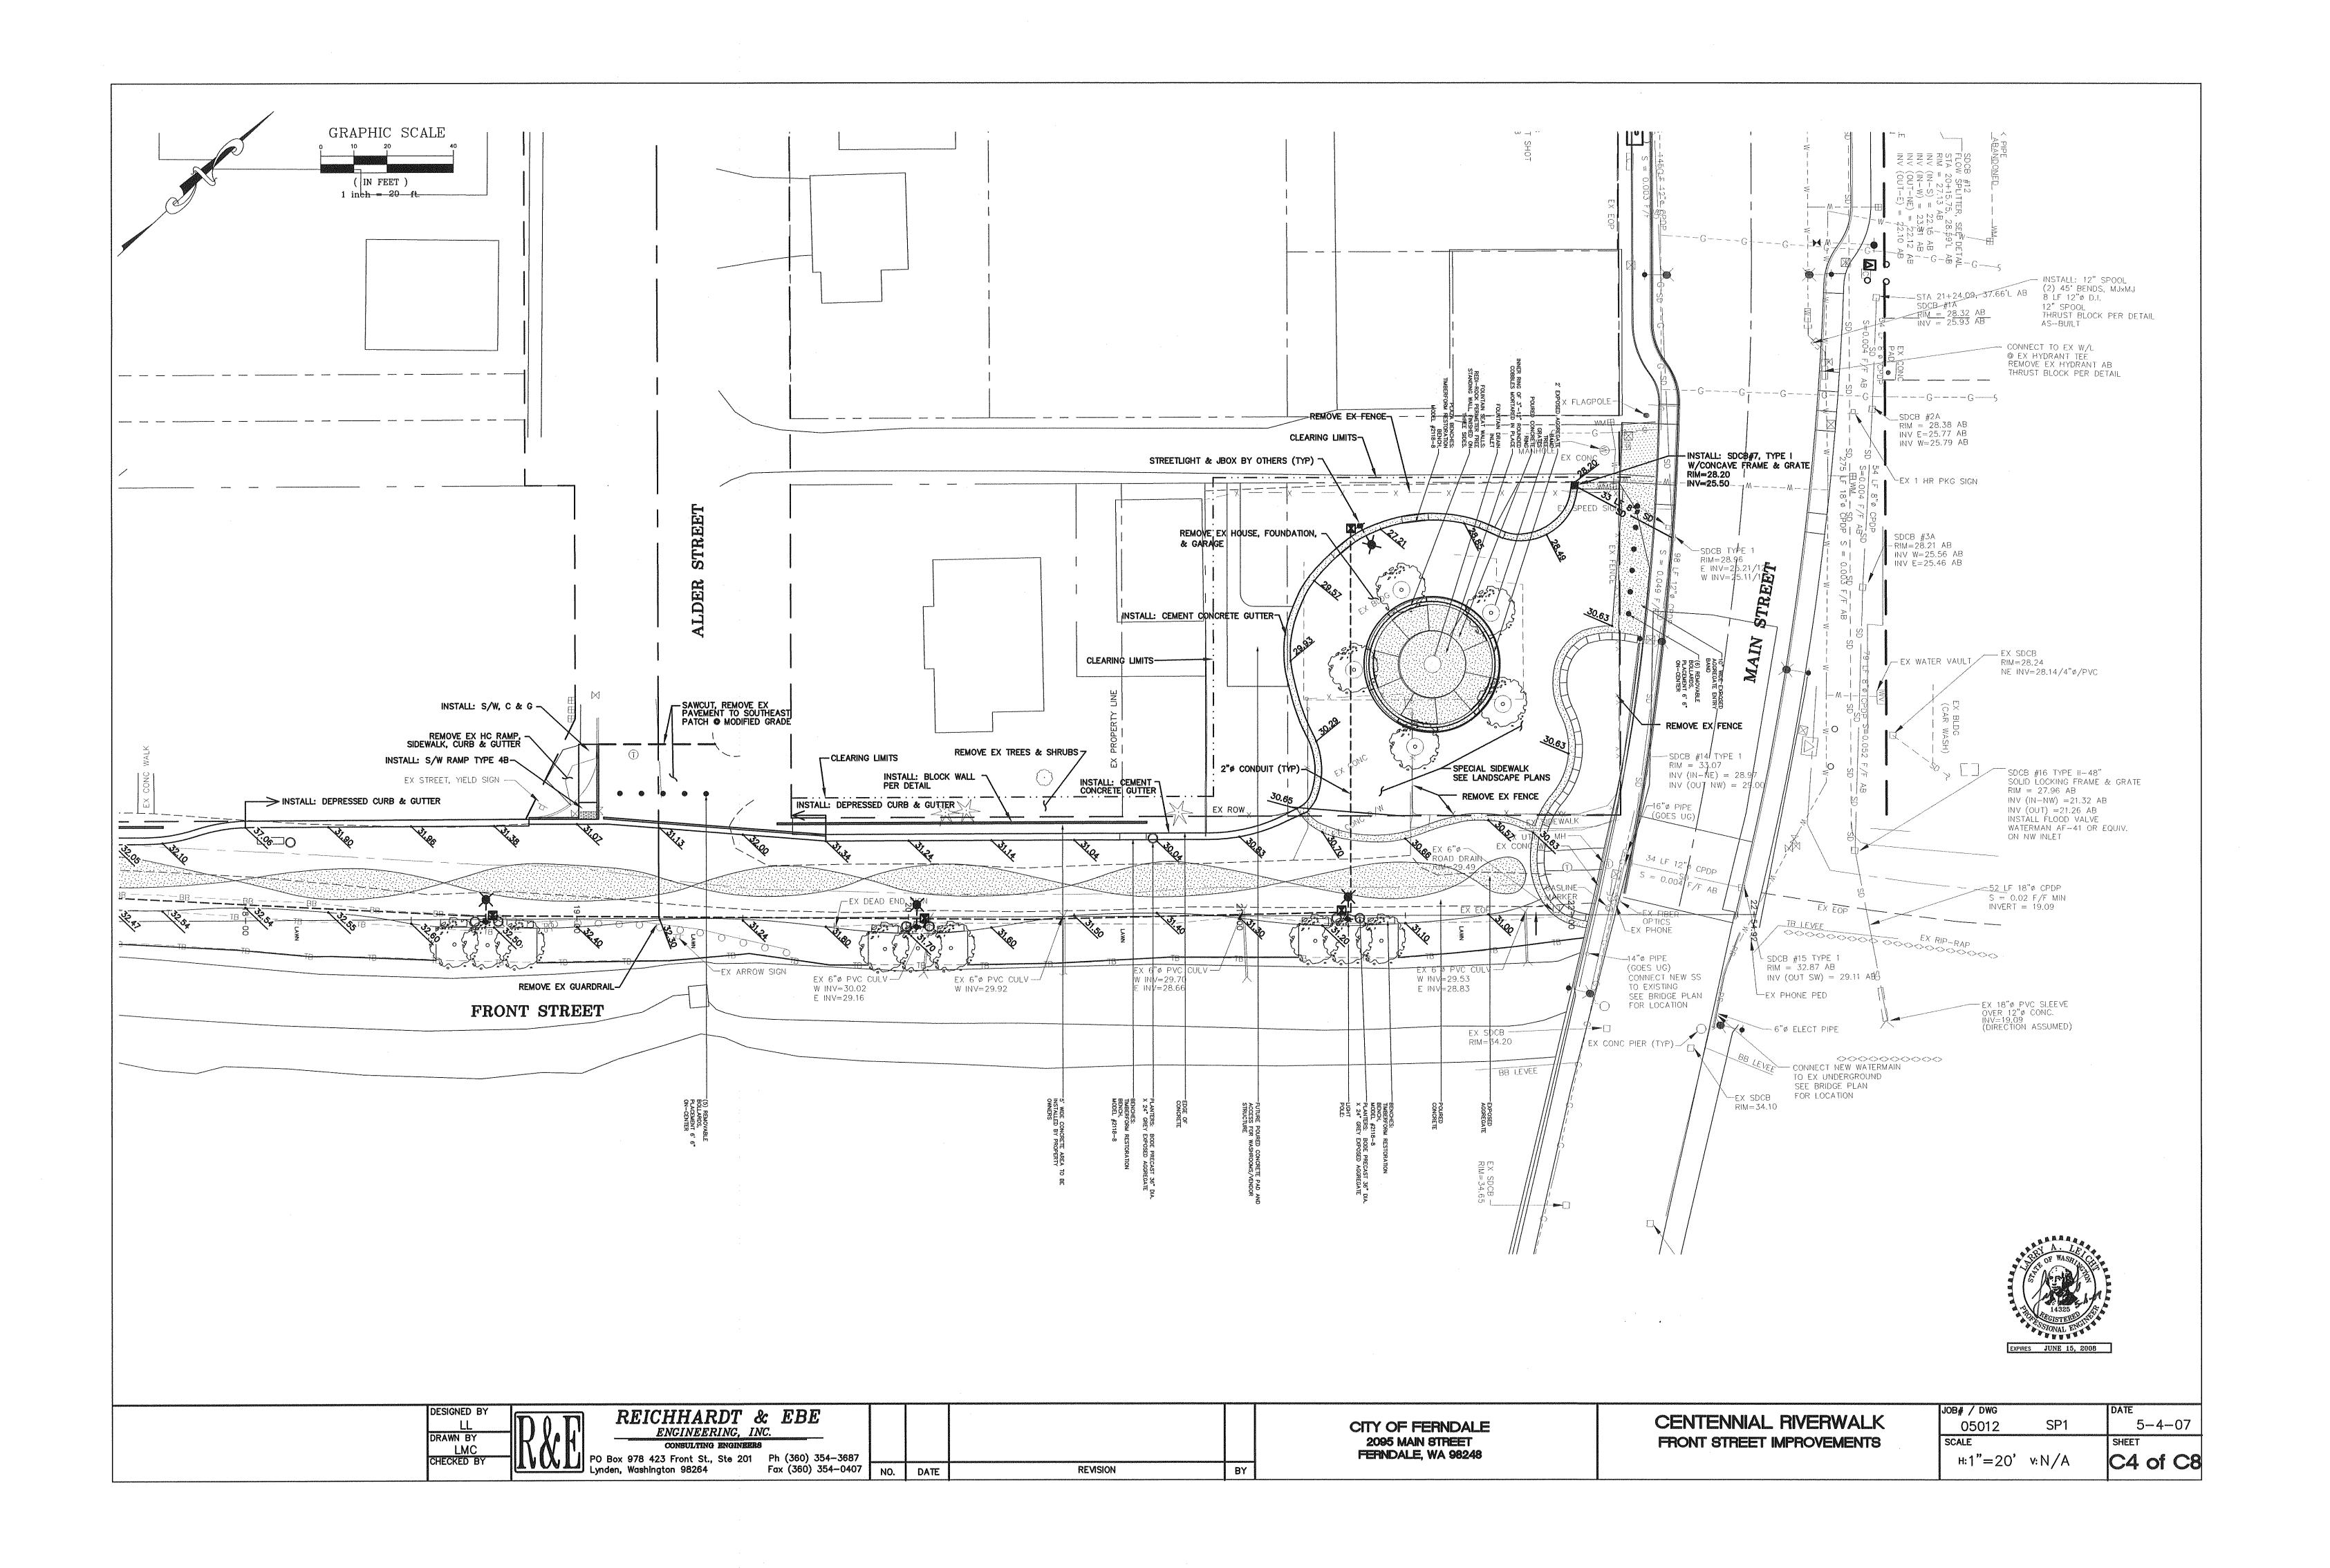

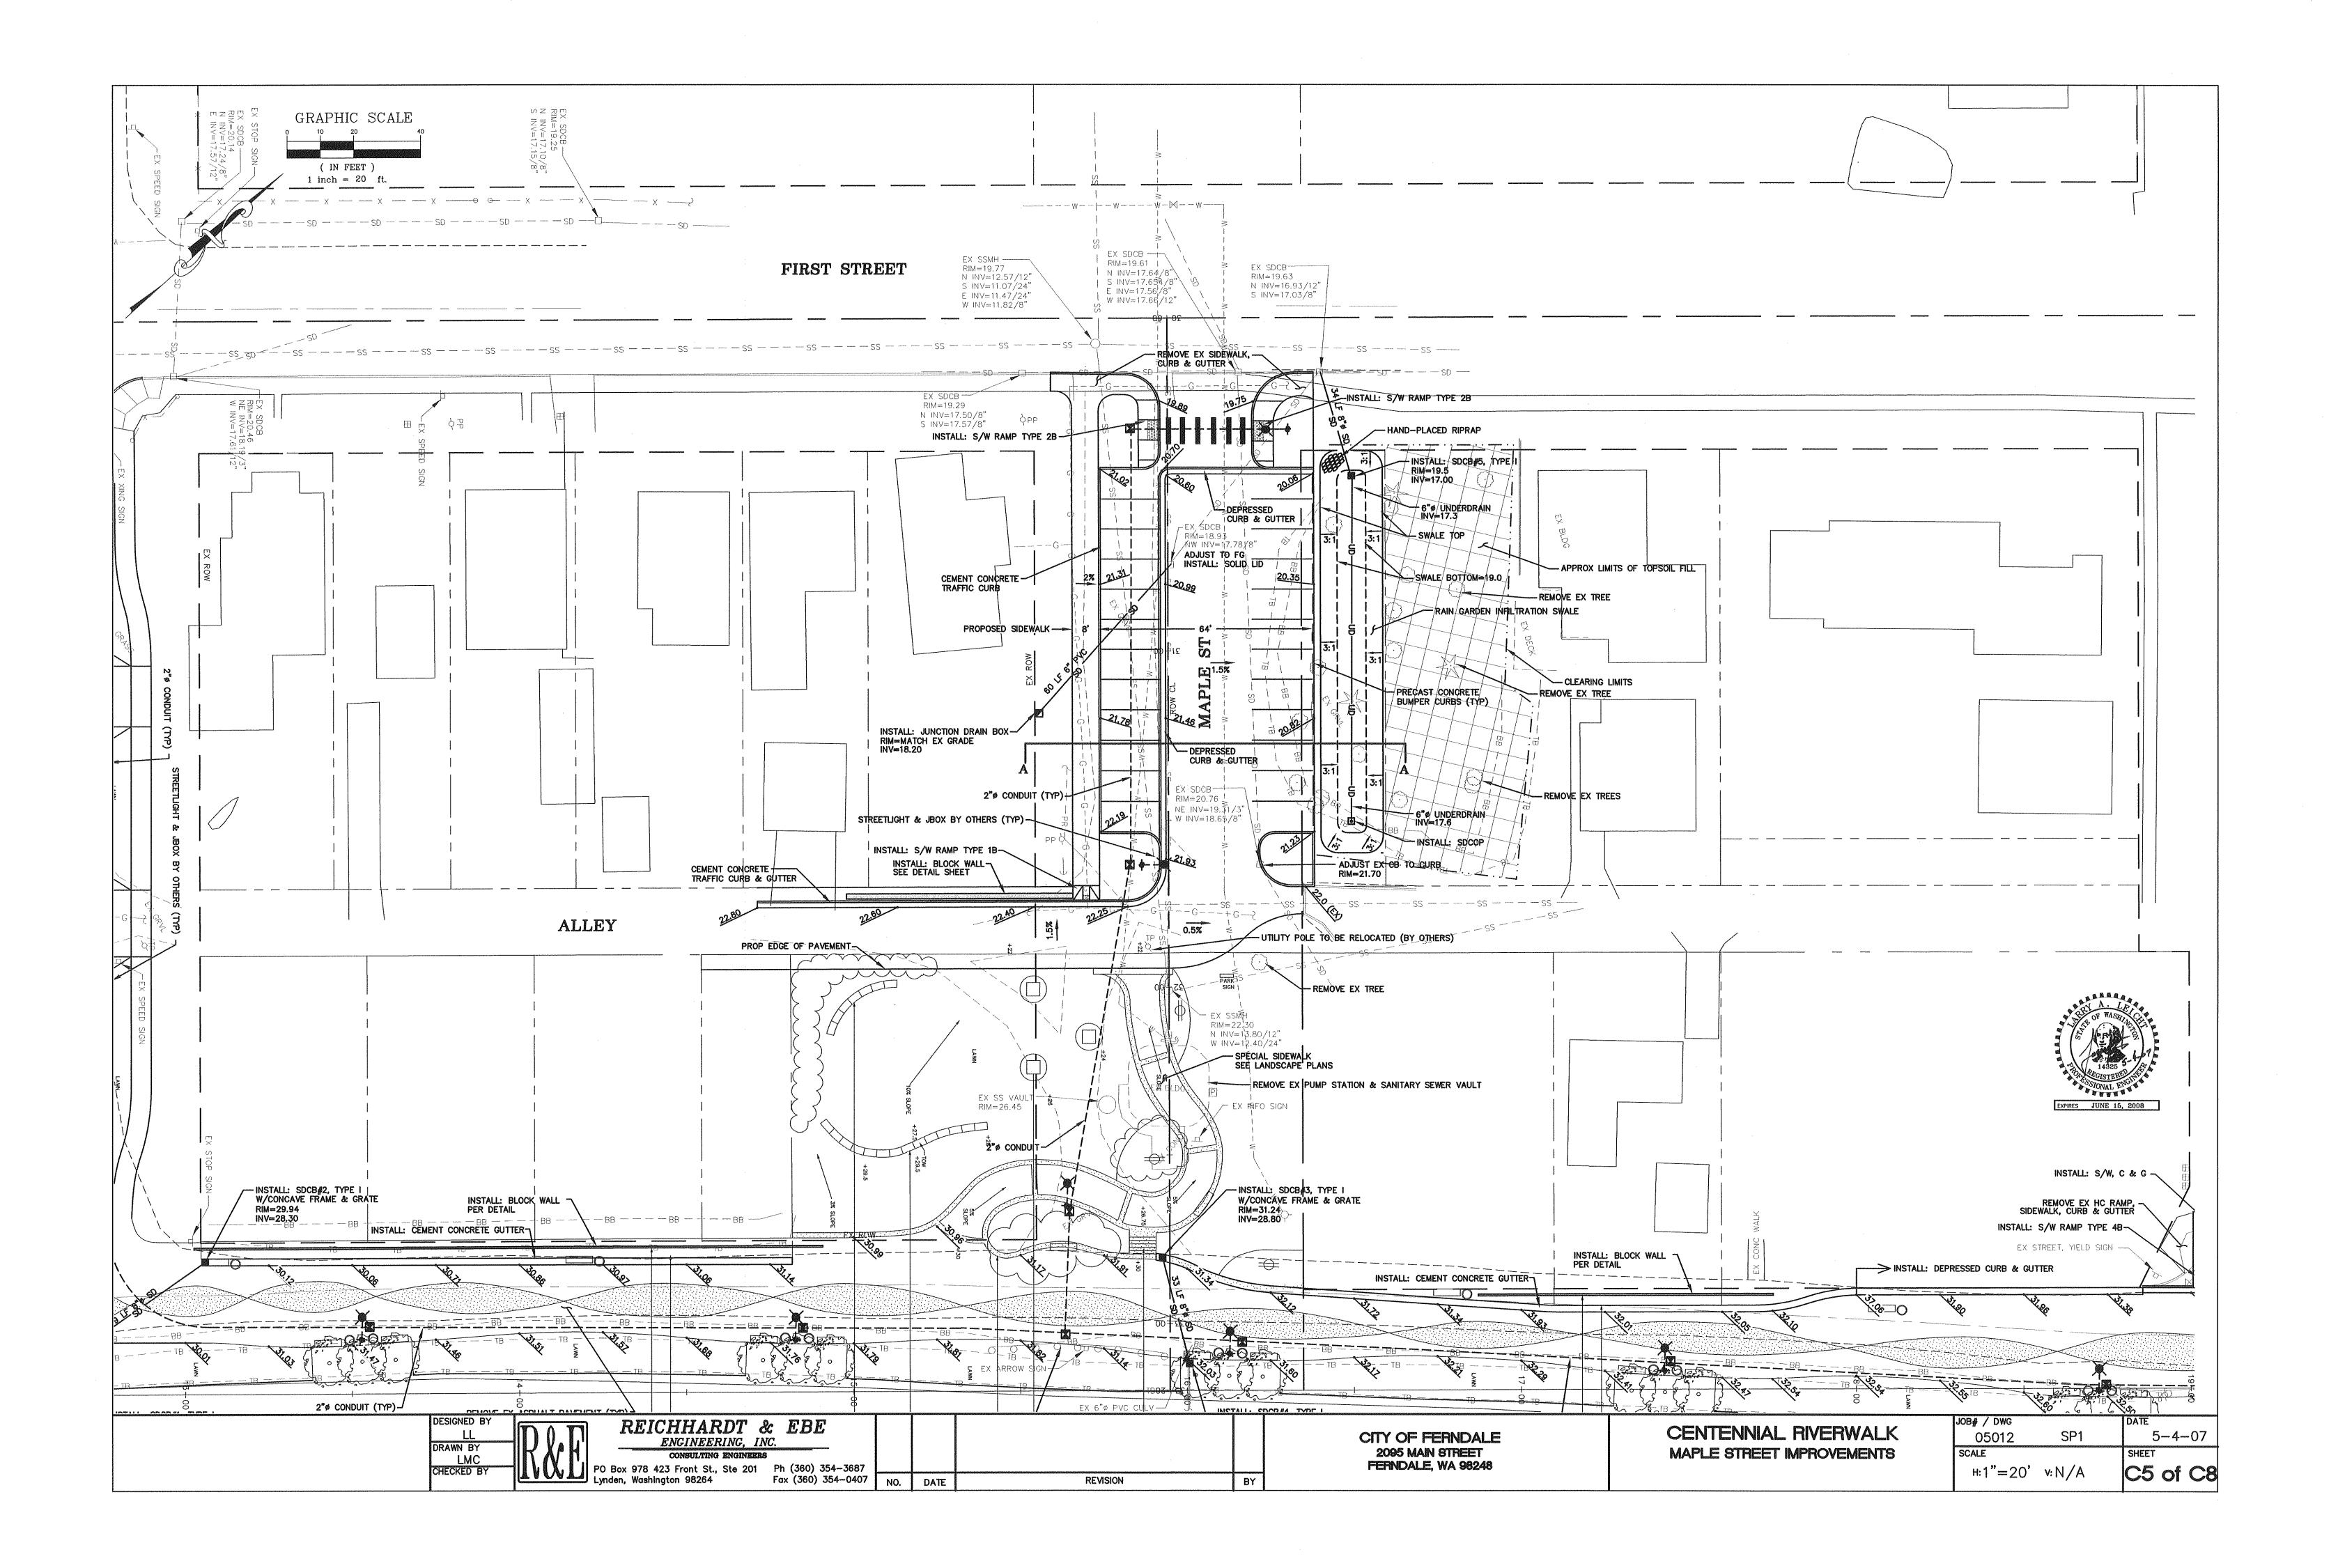


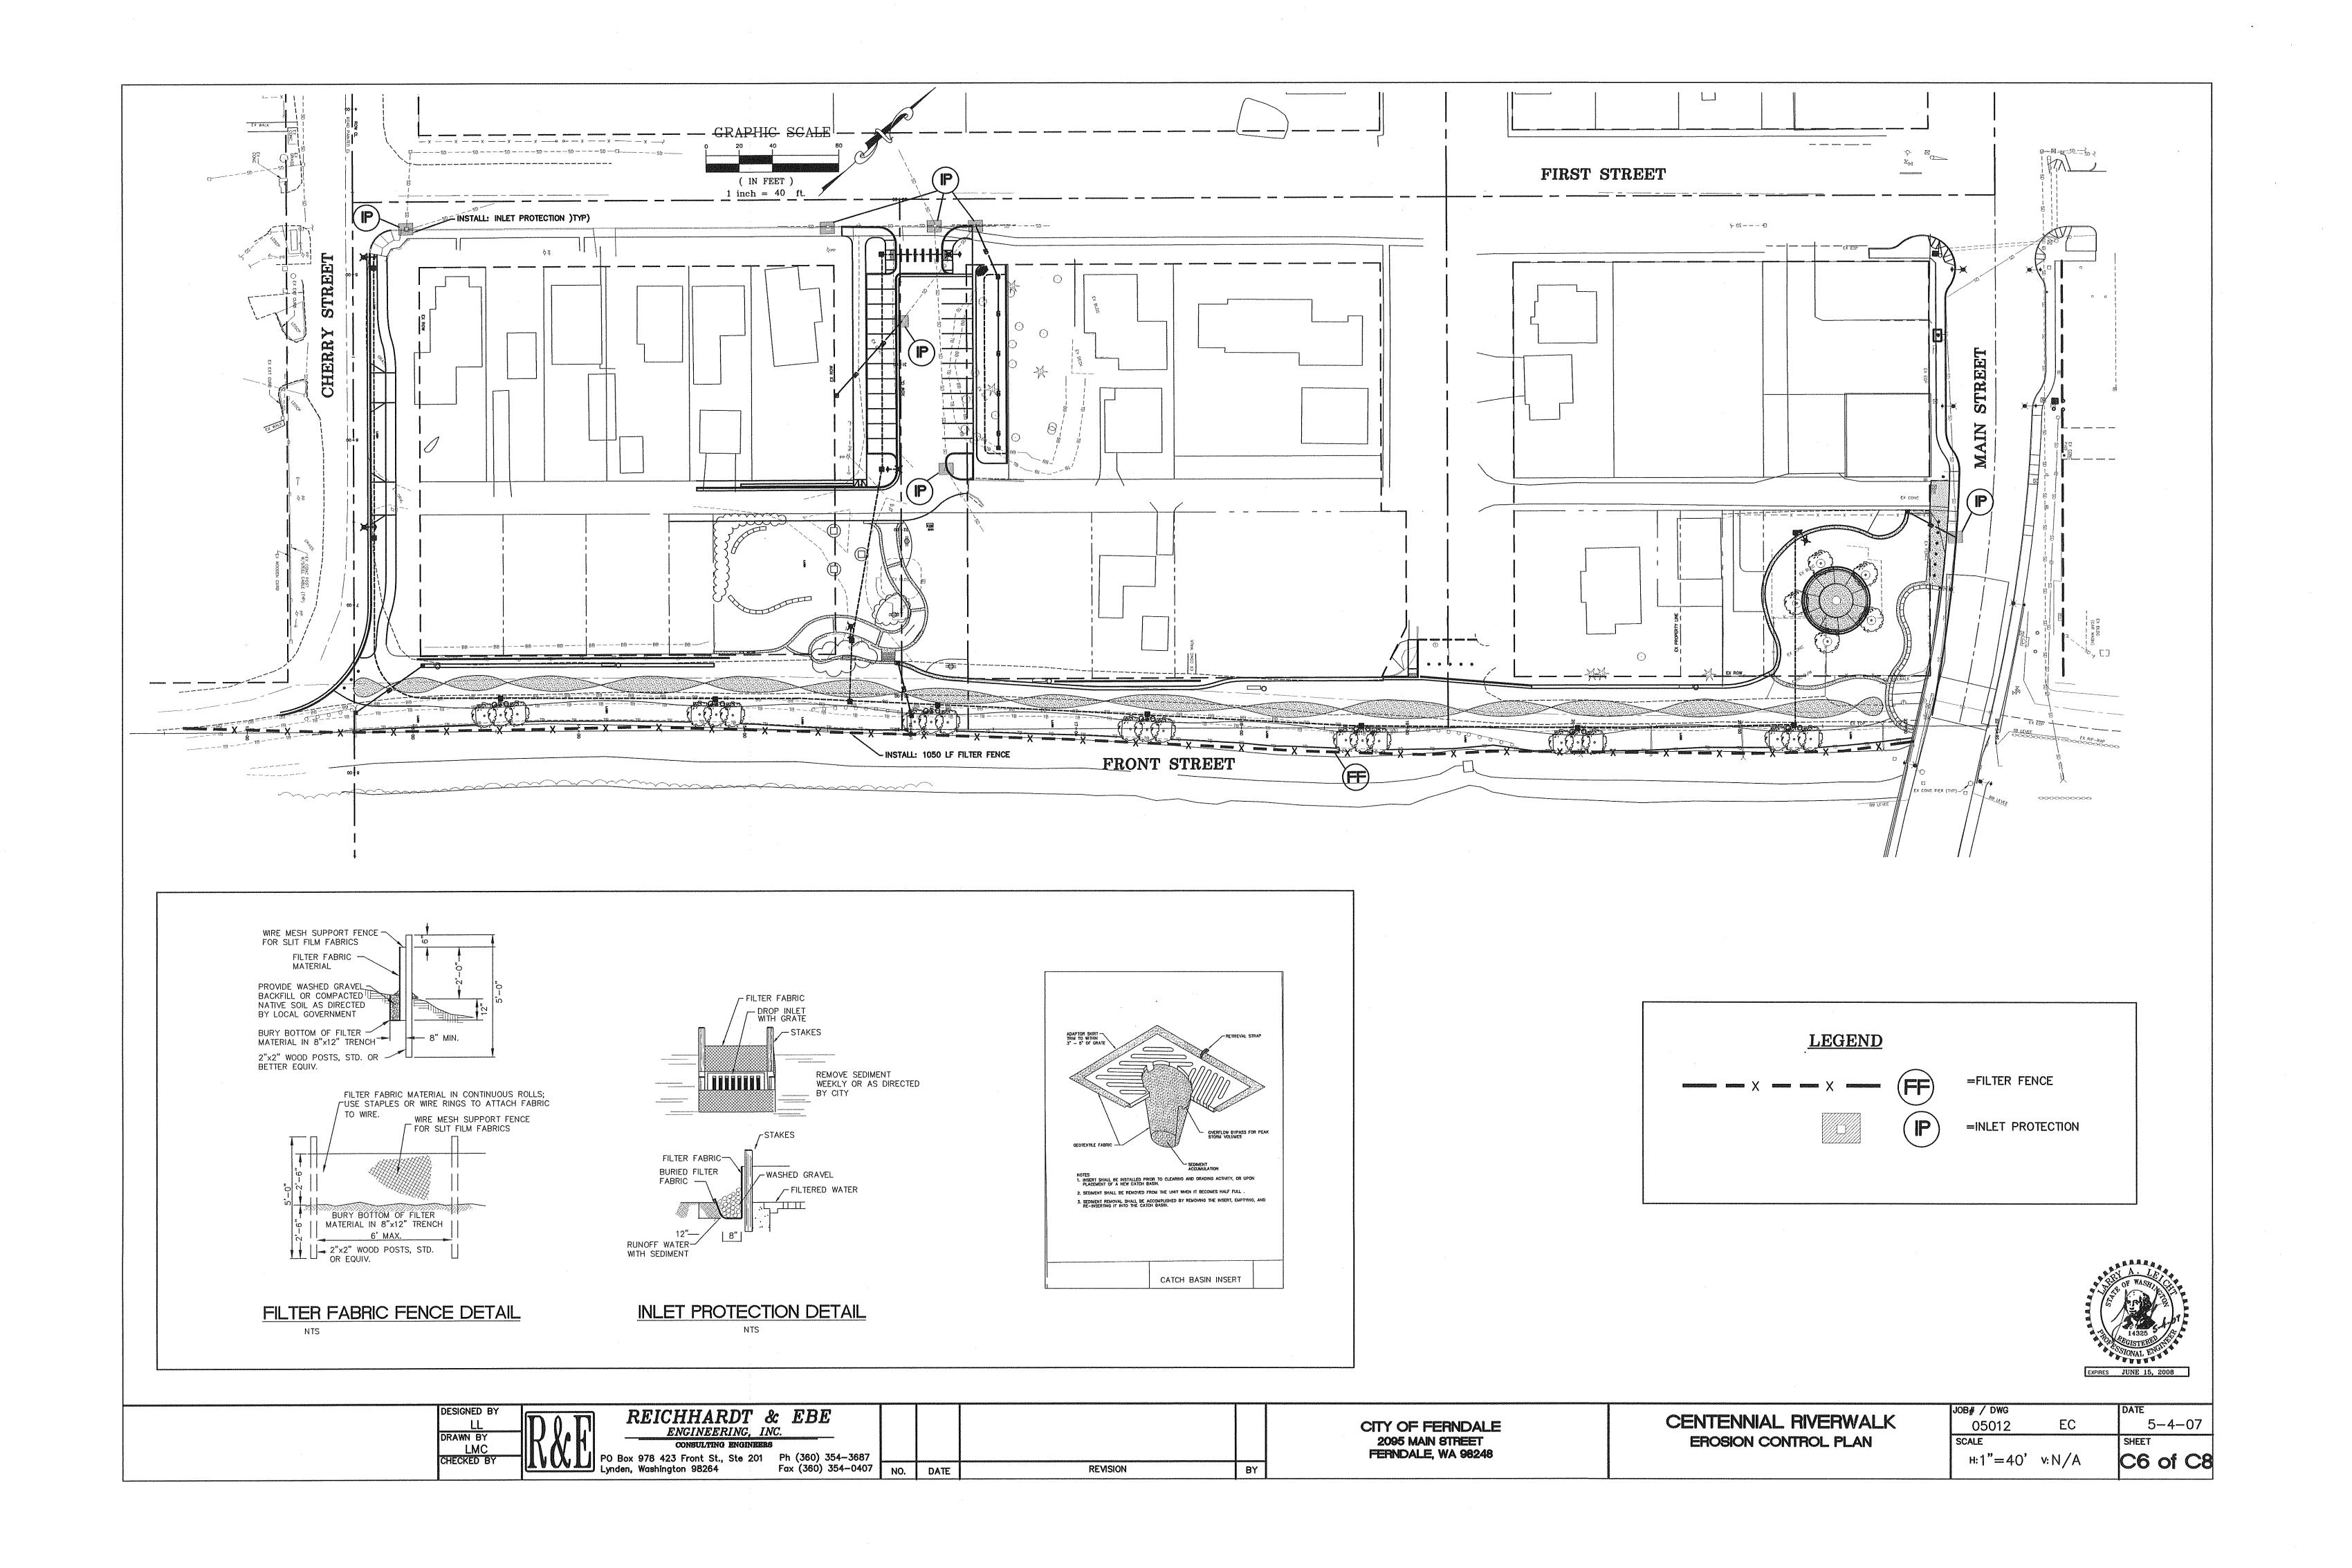

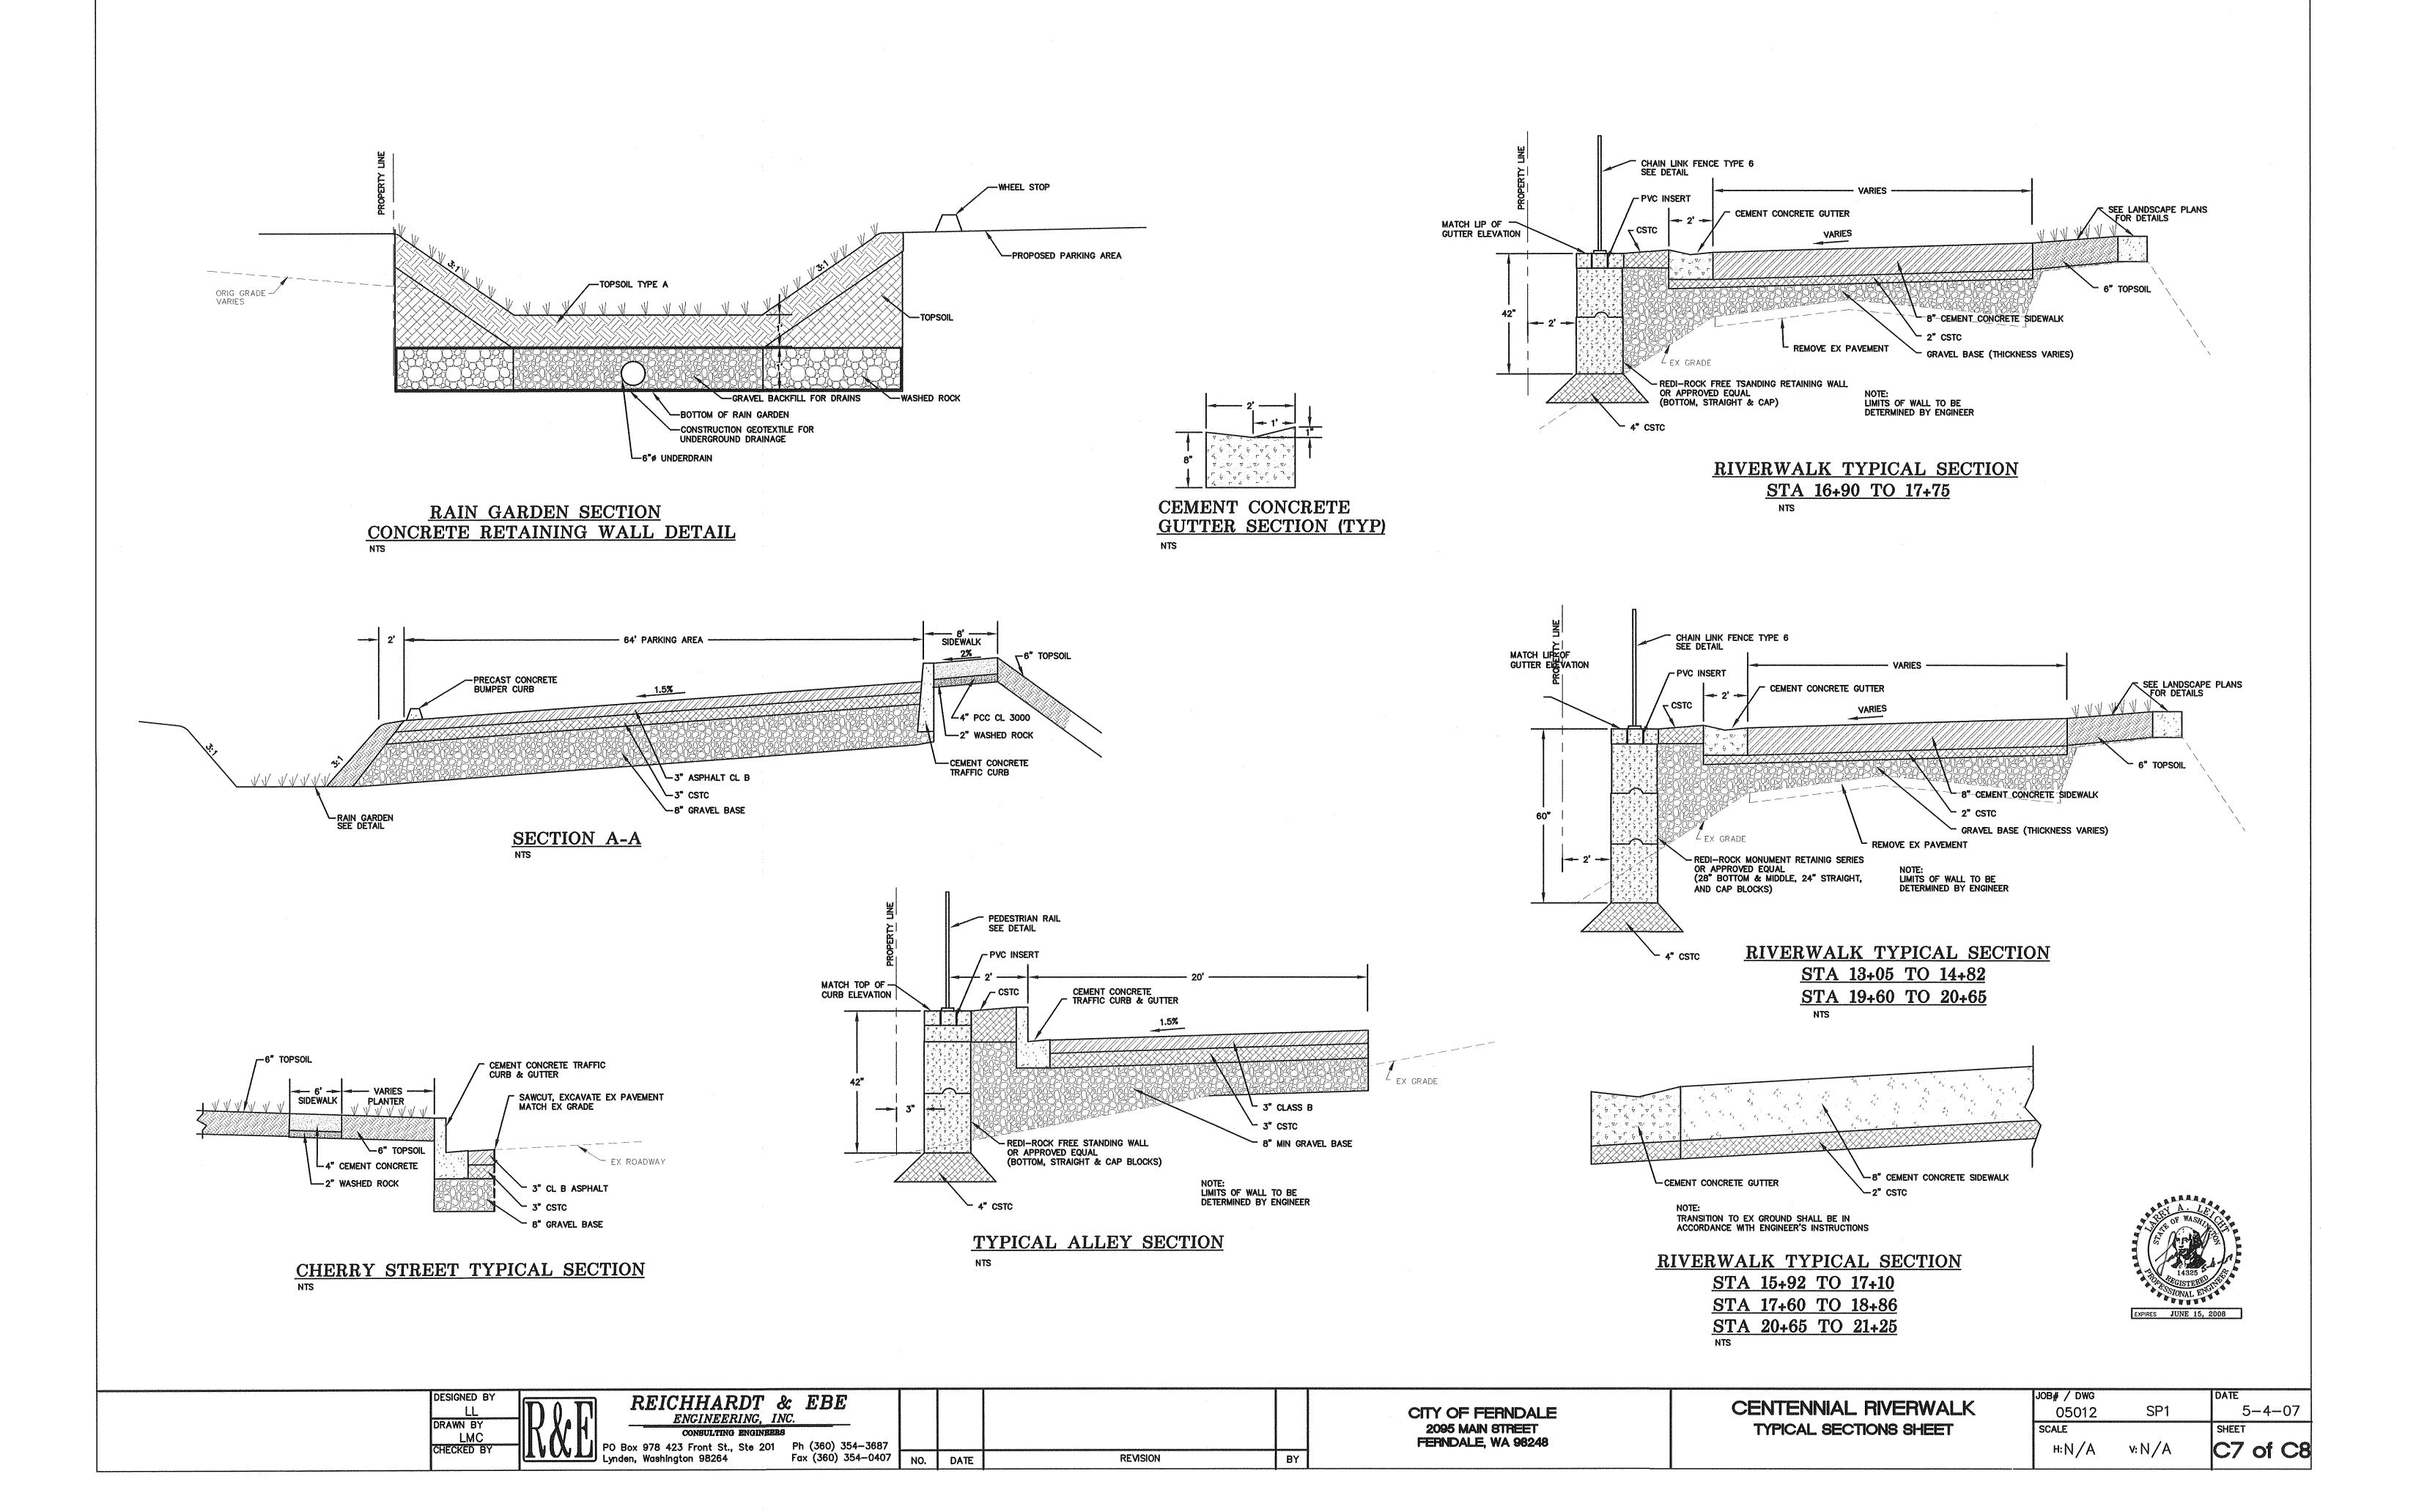

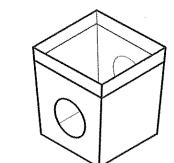


PROVIDE GRATE COVER TO ALLOW OVERLAND DRAINAGE SLOPE FROM J-BOX TO SADDLE TO BE 2%

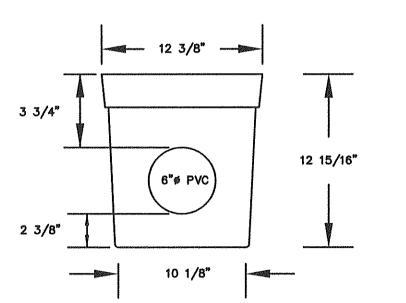


SPECIFICATION: NDS #1200,12003,12004, 12"x12" TAPERED CB OR EQUAL


JUNCTION DRAIN BOX DETAIL

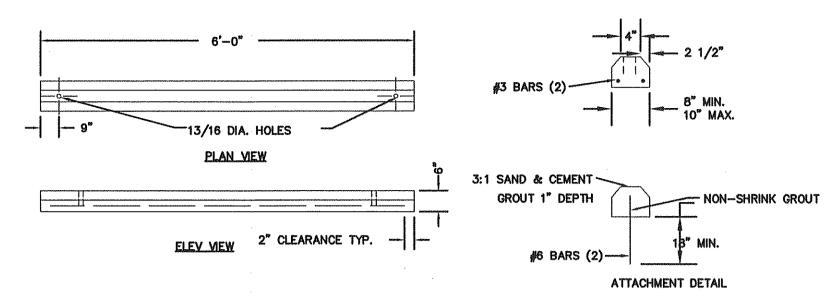

PRECAST CEMENT CONCRETE BUMPER CURB

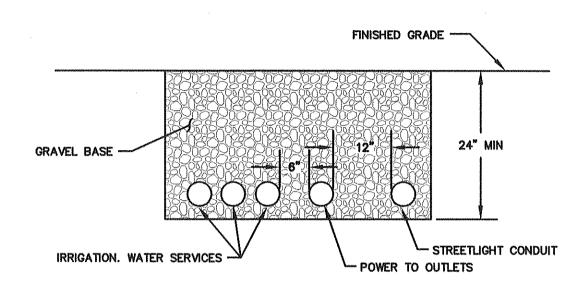



SHARED TRENCH DETAIL

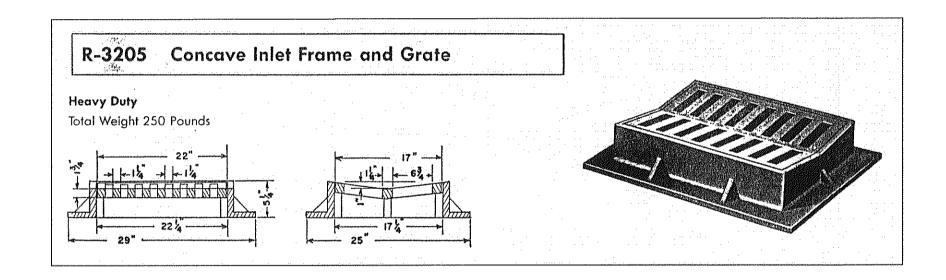

____ 2'6" ______ 2'6" ____


LIP OF GUTTER

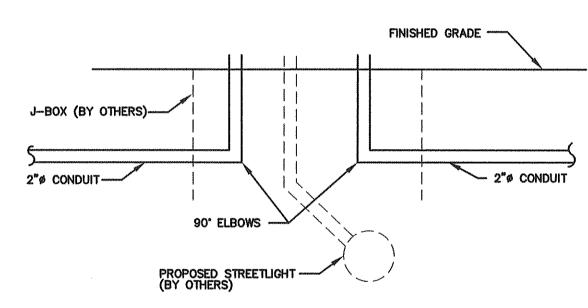

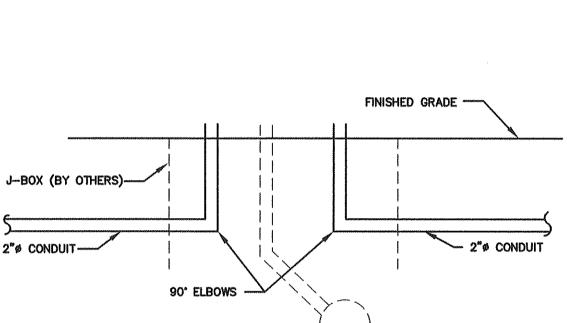


CONDUIT INSTALLATION @ J-BOX

MEMBER BRACE RAIL & TOP RAIL LINE & BRACE POST END, CORNER, & PULL POST GATE POST ROLL FORMED H-COLUMN ROLL FORMED H-COLUMN I.D. Pipe (Inches) Weight Per Foot Weight Per Foot I.D. Per Foot Pipe Per Foot Size Per Foot Pipe Size (Inches) Pipe | Per Foot | LENGTH (Inches) (Pounds) (Pounds) (Inches) (Pounds) (Inches) (Inches) (Pounds)

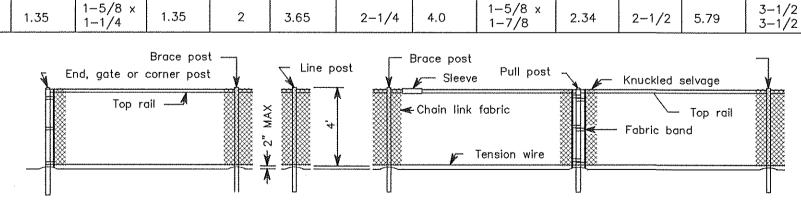

CHAIN LINK FENCE TYPE 6

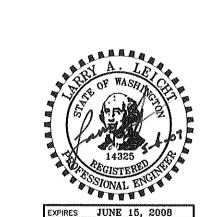

3" 18" — 18" — 2% — 1 1/2" APART VERTICALLY	NOTE: ON CURB SLOPES GREATER THAN 10% THE SLOPE OF THE FRAME AND GRATE IS TO BE SET AT THE DIRECTION OF THE ENGINEER. SAME SLOPE
2#4×5'	0.10TOP OF CURB
SLOPE 8% FRONT TO BACK	
SECTION B-B	I.C. FRAME & GRATE ADJUSTING RING CONC. BOX
	<u>SECTION A-A</u>

NOTE: USE NO. 4 BAR THROUGHOUT

TYPICAL CATCH BASIN

NTS

					.,
REICHHARDT & EBE ENGINEERING, INC.					
CONBULTING ENGINEERS					
O Box 978 423 Front St., Ste 201 Ph (360) 354-3687					
ynden, Washington 98264 Fax (360) 354-0407	NO.	DATE	REVISION	BY	

1-1/4 2.27

CENTE CITY OF FERNDALE 2095 MAIN STREET DETAILS FERNDALE, WA 98248

GENERAL NOTES

800-424-5555.

Drawings and specifications.

the Civil Drawings and specifications.

The City will provide all construction staking on this project.

3-1/2 9.1

project.

otherwise by the contract documents.

two feet of proposed cover shall be removed.

Contractor to field verify these locations prior to construction.

All work shall conform to the standard plans and specifications of the Washington State Department of Transportation (WSDOT) and City of Ferndale standards unless indicated

Plug all culverts, sewers, and conduits prior to abandonment. Any pipe with less than

The location of existing utilities shown is approximate. It is the responsibility of the

The Contractor shall be responsible for contacting any and all utilities in the area prior to

beginning an work on this project. The one-call number for underground utilities is 1-

The Contractor shall notify residents and businesses 48 hours in advance of any work

Drivew ays shall not be closed more than 4 hours without owner's consent. Concrete

provided on one side of the road whenever drivew ay access is limited.

pours shall be staggered such that access is provided whenever possible. Parking shall be

Rain Garden excavation, grading, topsoil, and underdrain system shall be constructed as

detailed in the Civil Drawings and specifications. Rain Garden work shall extend from

All landscaping including landscaping in the Rain Garden and cleared area to the north

All irrigation and fountain installation shall be constructed as detailed in the Landscaping

enclosures shall be constructed as detailed in the Electrical Drawings and specifications. Streetlight conduit and streetlight junction boxes shall be constructed in accordance with

shall be constructed as detailed in the Landscaping Drawings and specifications.

Electrical installation needed for outlets, enclosures, electrical services, panels, and

the edge of the Maple Street parking lot to the north, west, and east limits of clearing.

affecting access or service and shall minimize interruptions to drivew ays adjacent to the

	JOB# / DWG		DATE
ENNIAL RIVERWALK	05012	SP1	5-4-07
LS AND GENERAL NOTES	SCALE		SHEET
	H:N/A	v:N/A	C8 of C8


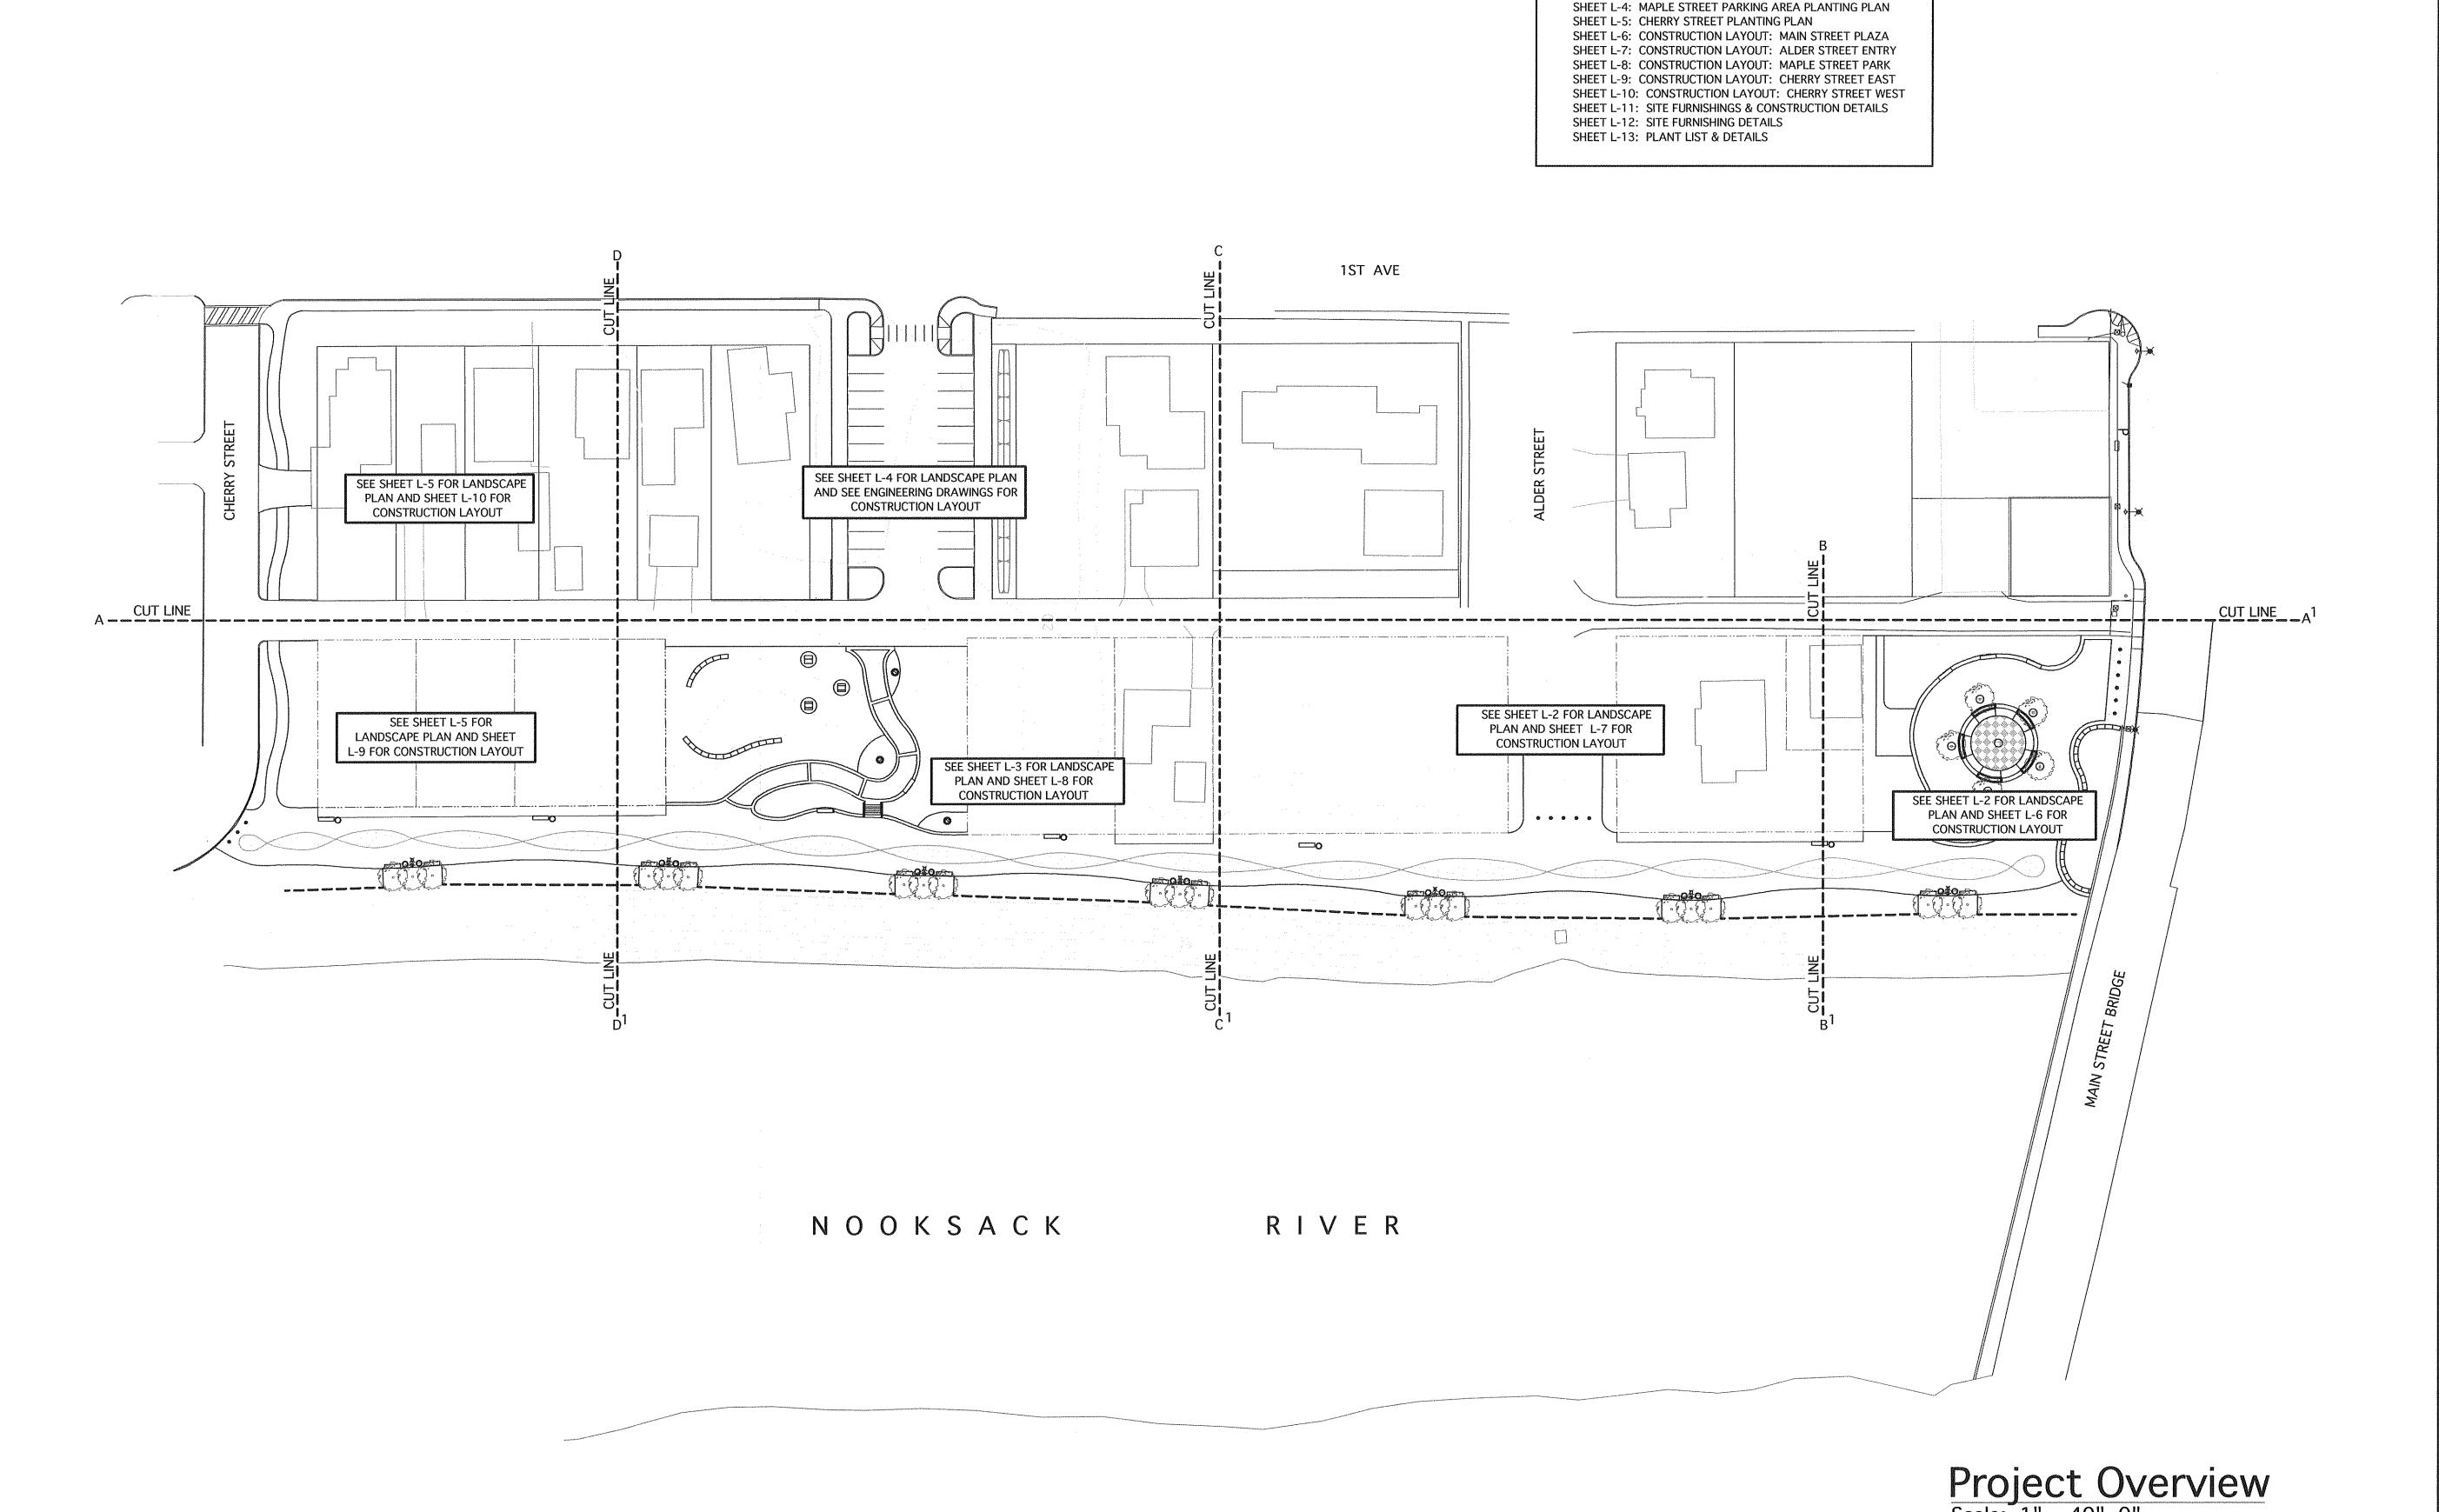


TABLE OF CONTENTS

SHEET L-2: MAIN STREET PLAZA PLANTING PLAN SHEET L-3: MAPLE STREET PARK PLANTING PLAN

SHEET L-1: PROJECT OVERVIEW

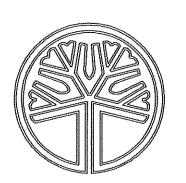

STATE OF WASHINGTON REGISTERED LANDSCAPE ARCHITECT

> PAUL M. GEORGE CERTIFICATE NO. 641



P.O. Box 5938
Bellingham, WA 98227
360-715-2119

cgroup@cascadedesigngroup.net


Paul George Landscape Architect

Centale, We sale, We sale, We sale, which sale, we sale, with sale, we sale, which sale, we sale, which sale, we sale, which sale, we sale, which sale, we sale, with sale, we sale, which sale, which sale, we sale, which sale, which sale, we sale, with sale, which sale, we sale, which sale, which sale, we sale, which sale, we sale, with sale, which sale, which sale, we sale, with sale, which sale, which sale, which sale, we sale, which sale, we sale, which sale, wh


REVISIONS


May 1, 2007

DATE: March 9, 2007

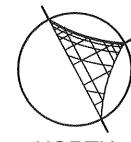


NORTH

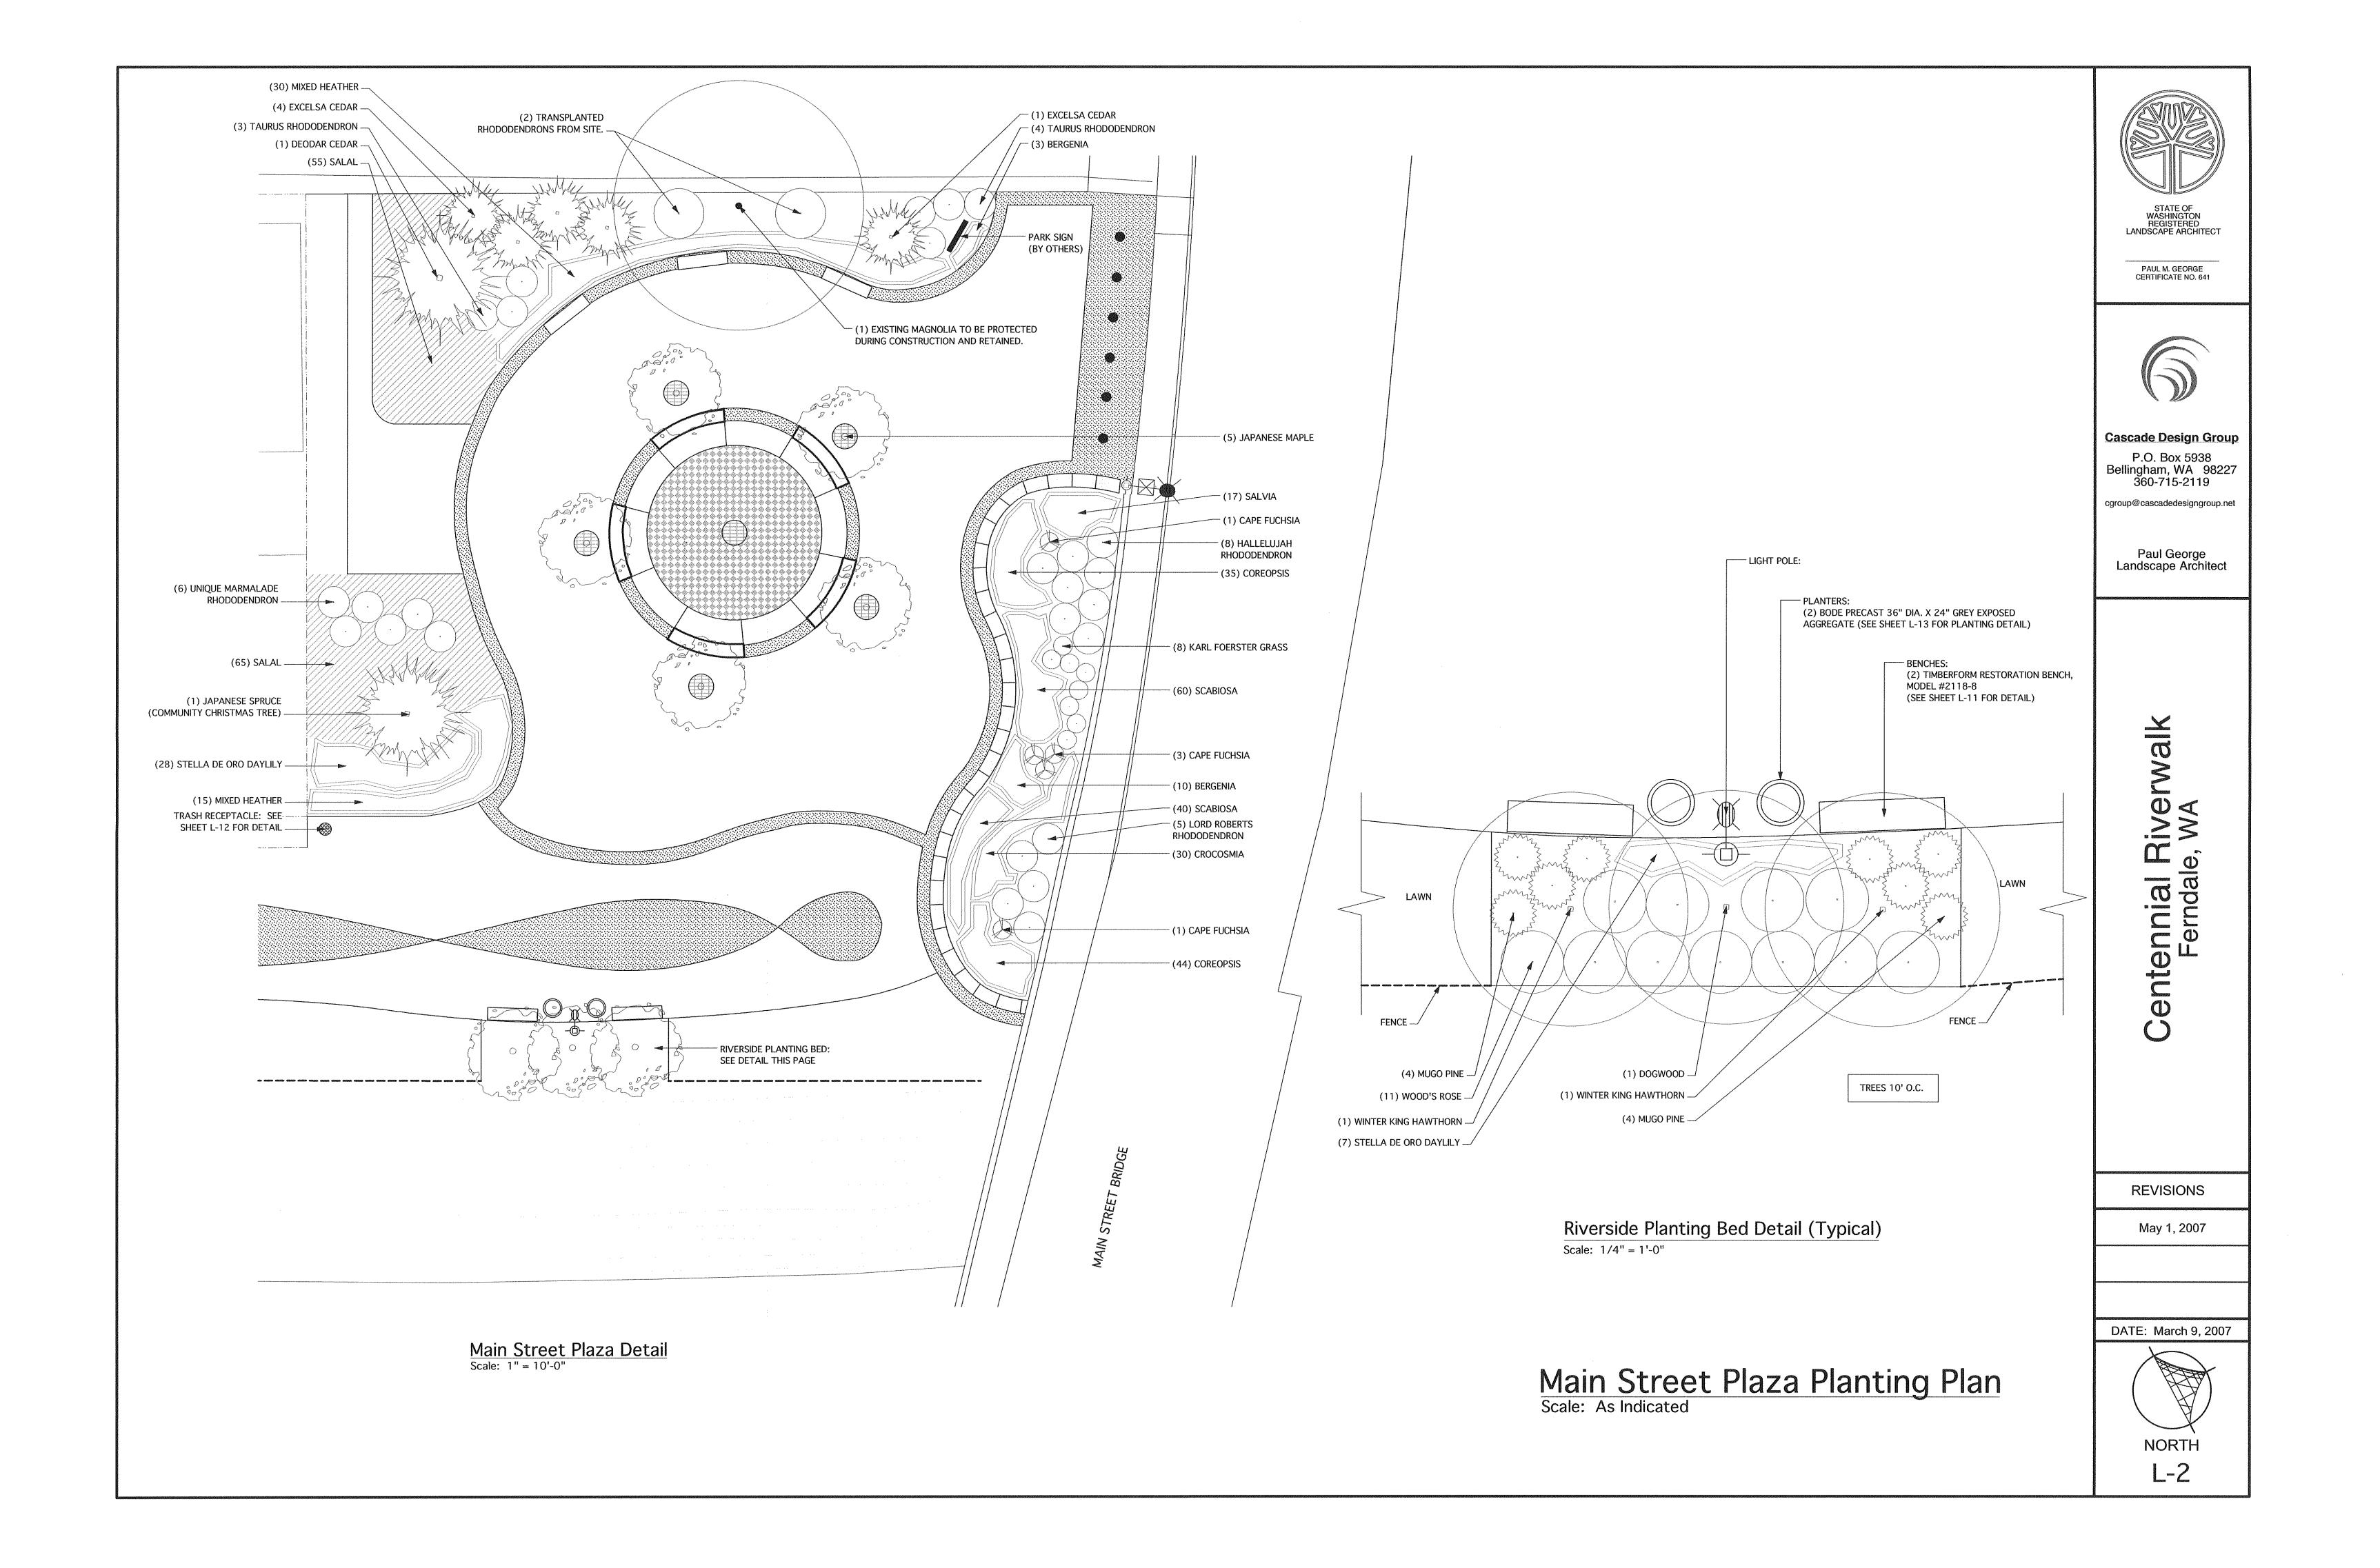

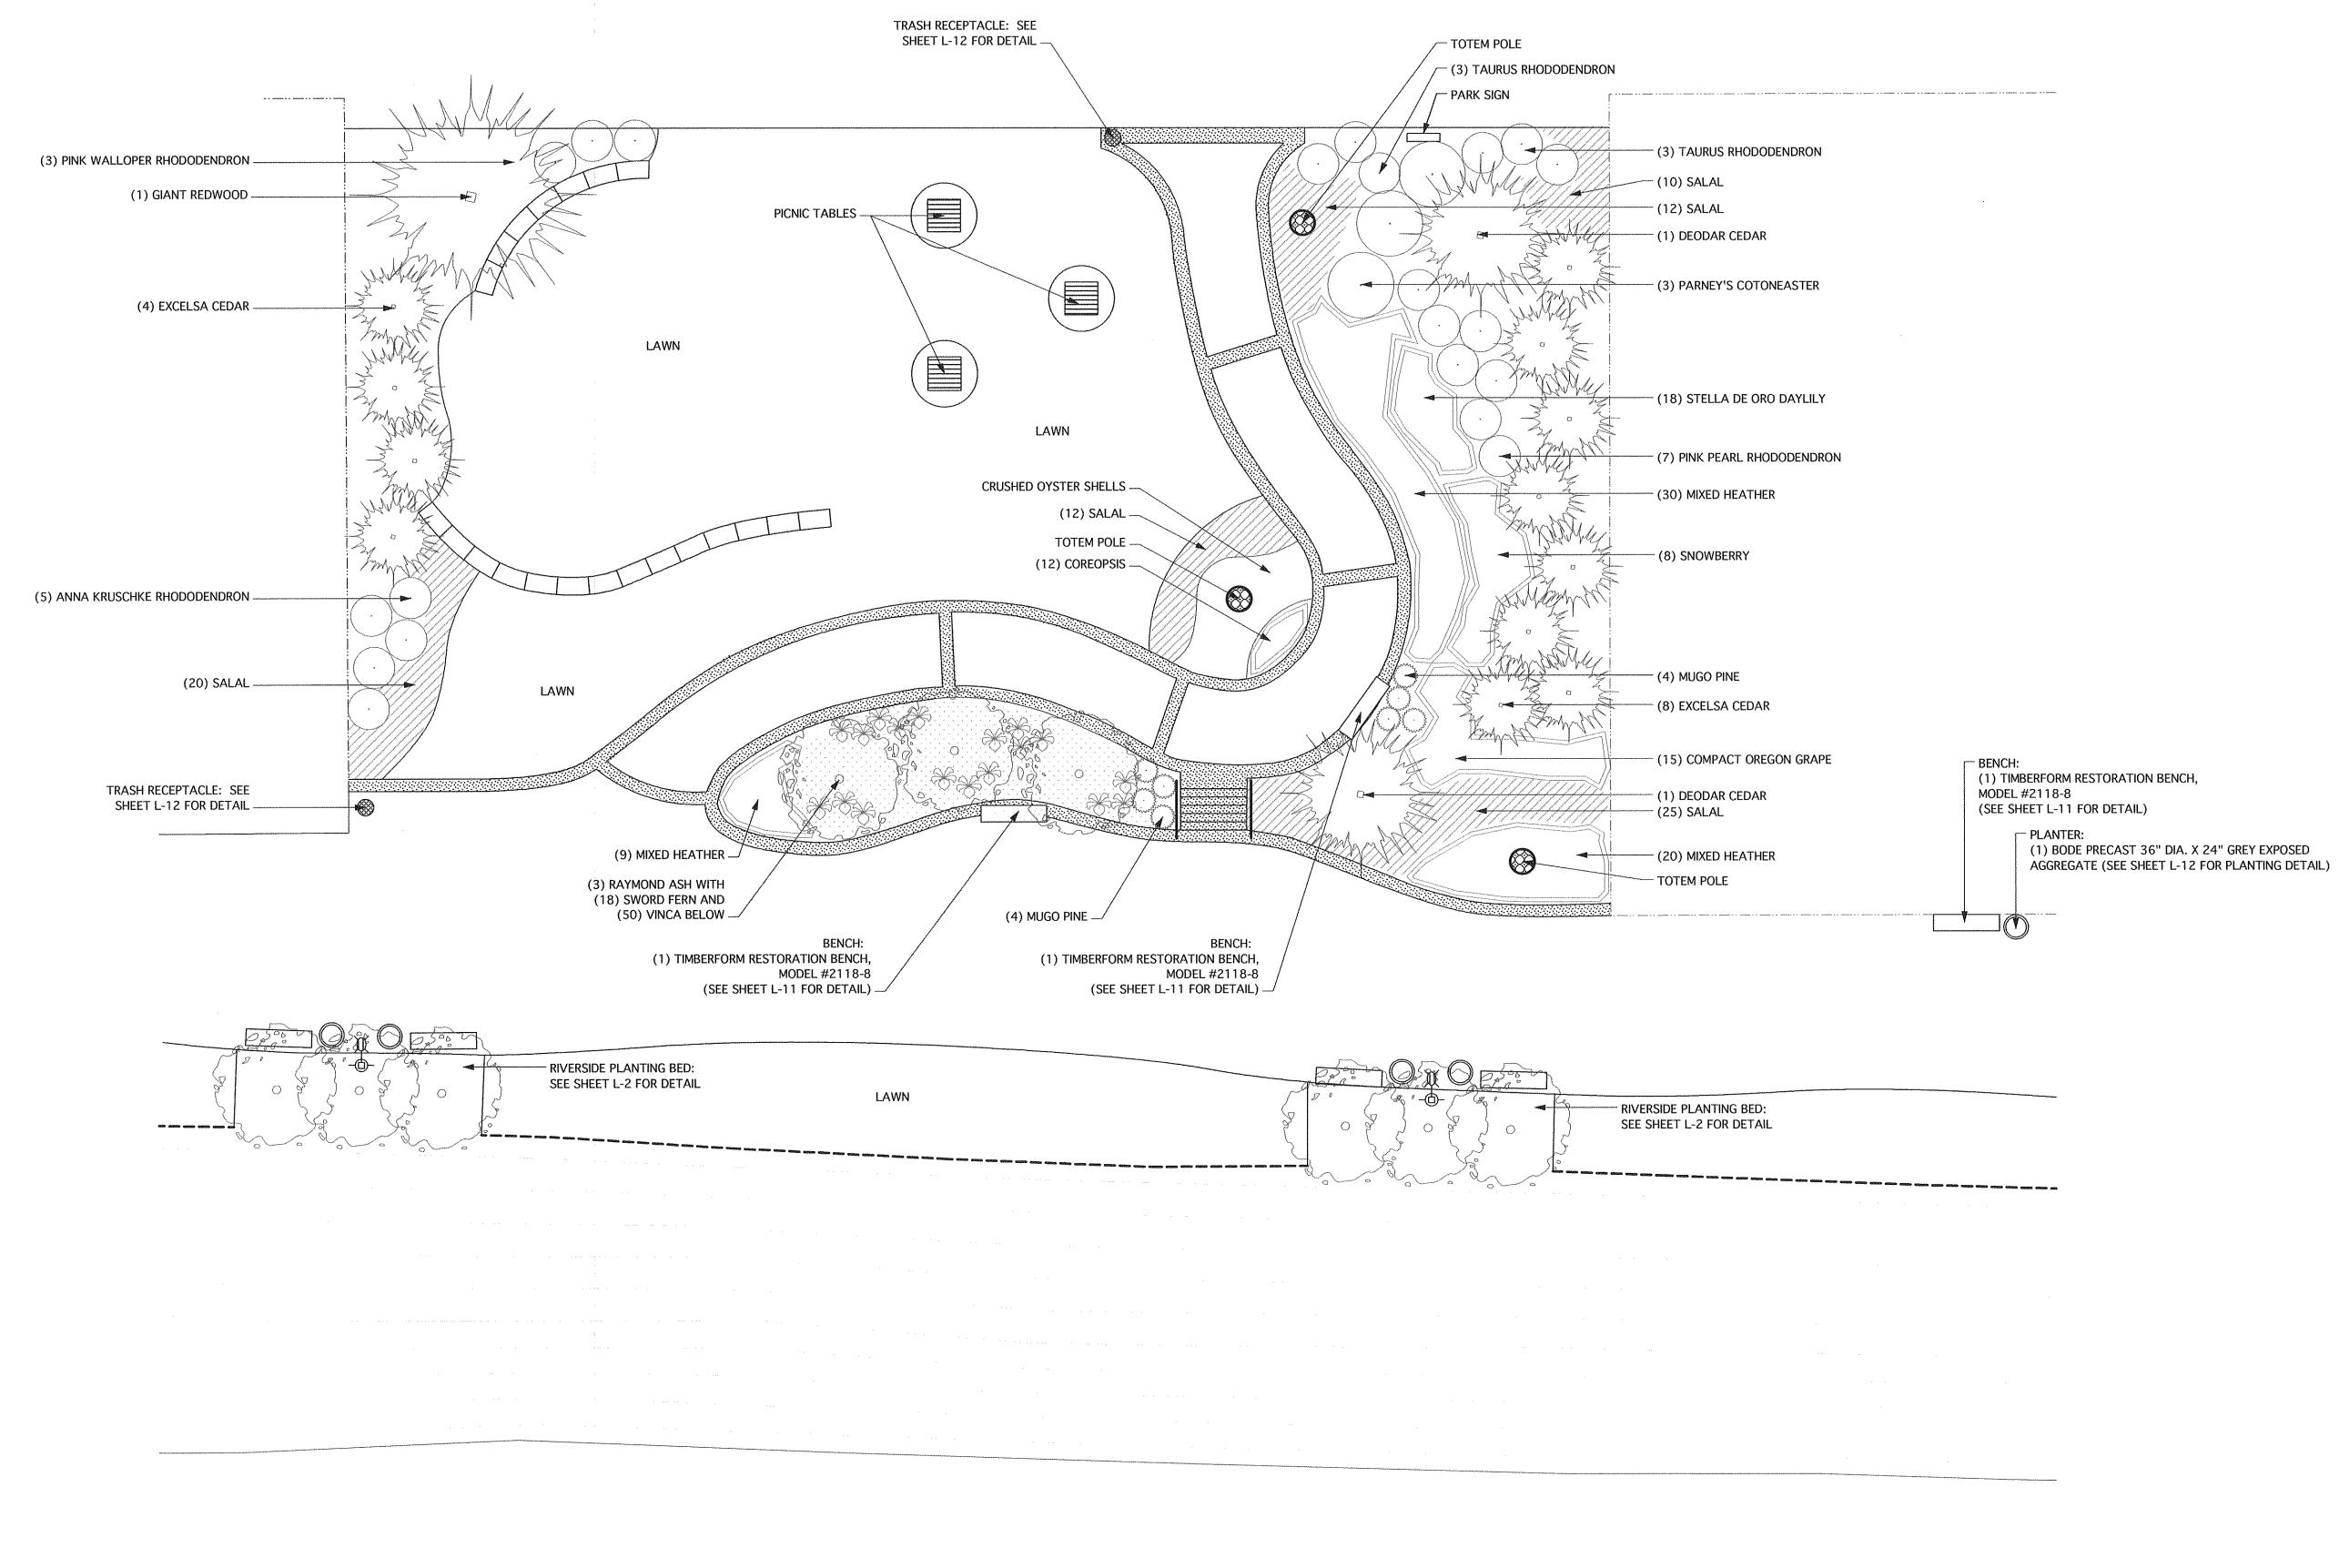

Maple Street Park Planting Plan
Scale: 1" = 10'-0"

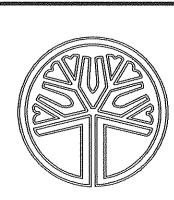

STATE OF WASHINGTON REGISTERED LANDSCAPE ARCHITECT

PAUL M. GEORGE CERTIFICATE NO. 641



Cascade Design Group P.O. Box 5938 Bellingham, WA 98227 360-715-2119

cgroup@cascadedesigngroup.net


Paul George Landscape Architect

Z S S


REVISIONS


May 1, 2007

DATE: March 9, 2007

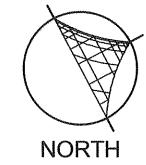


L-3

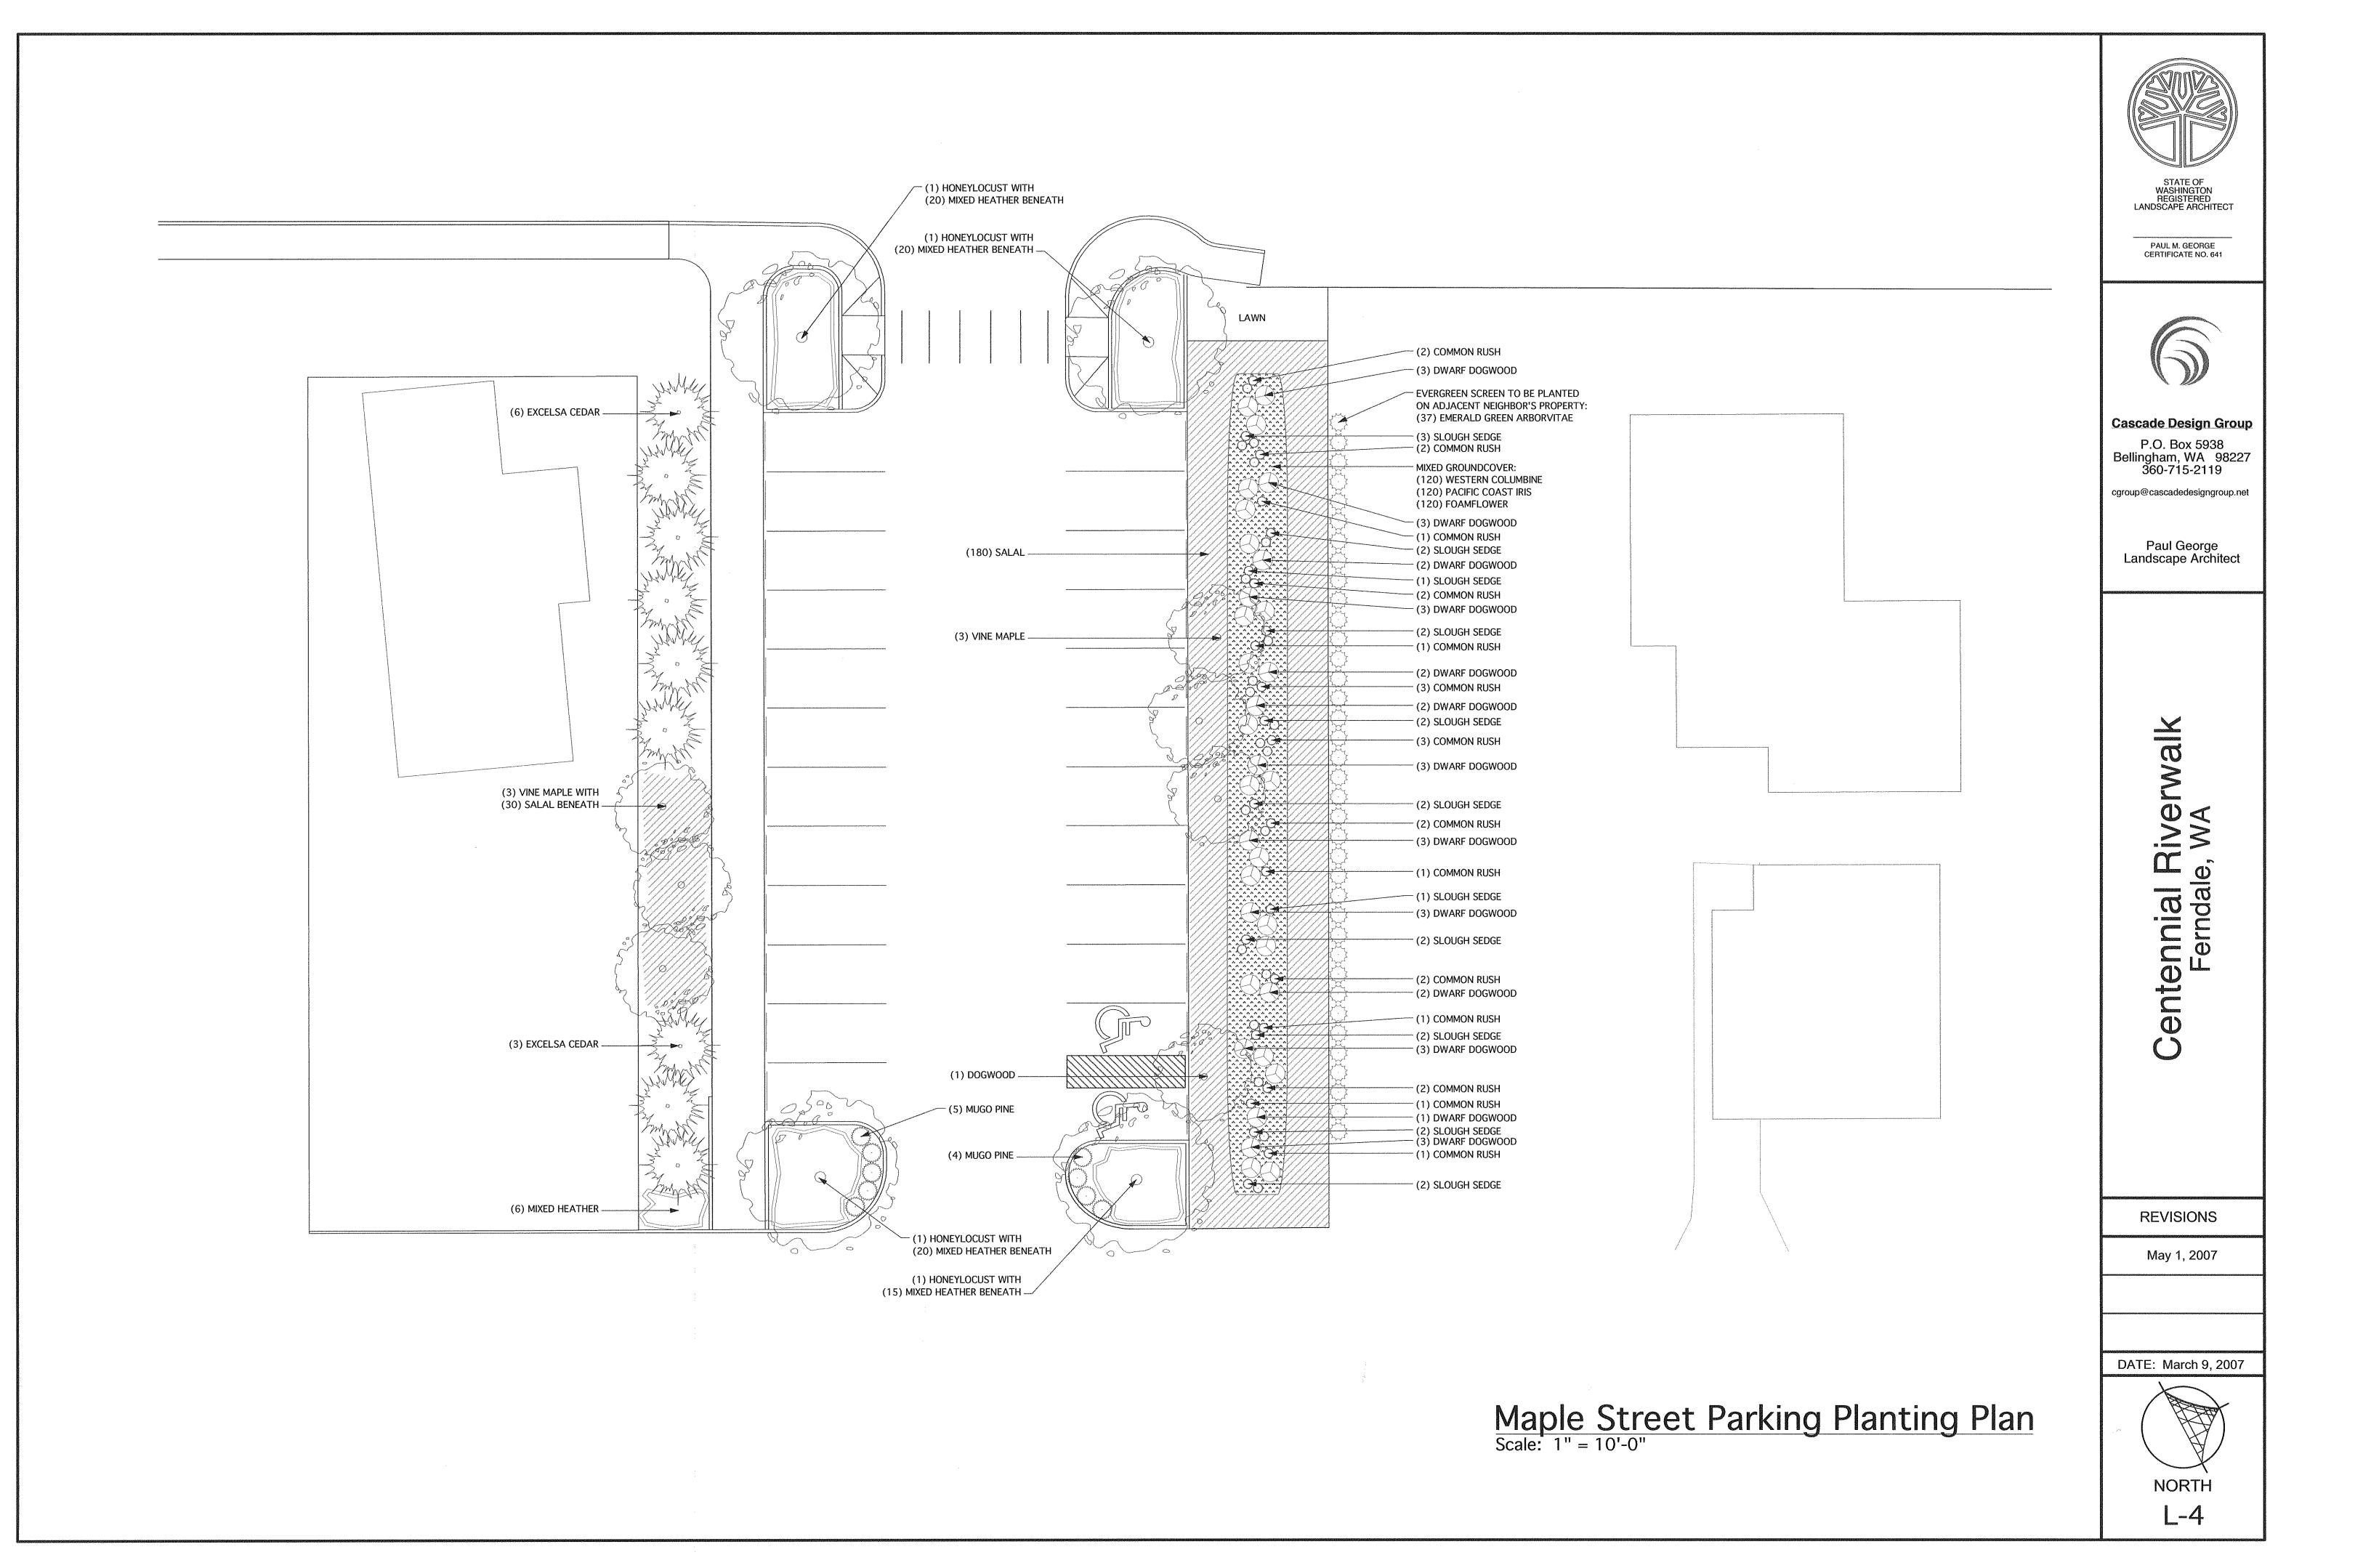

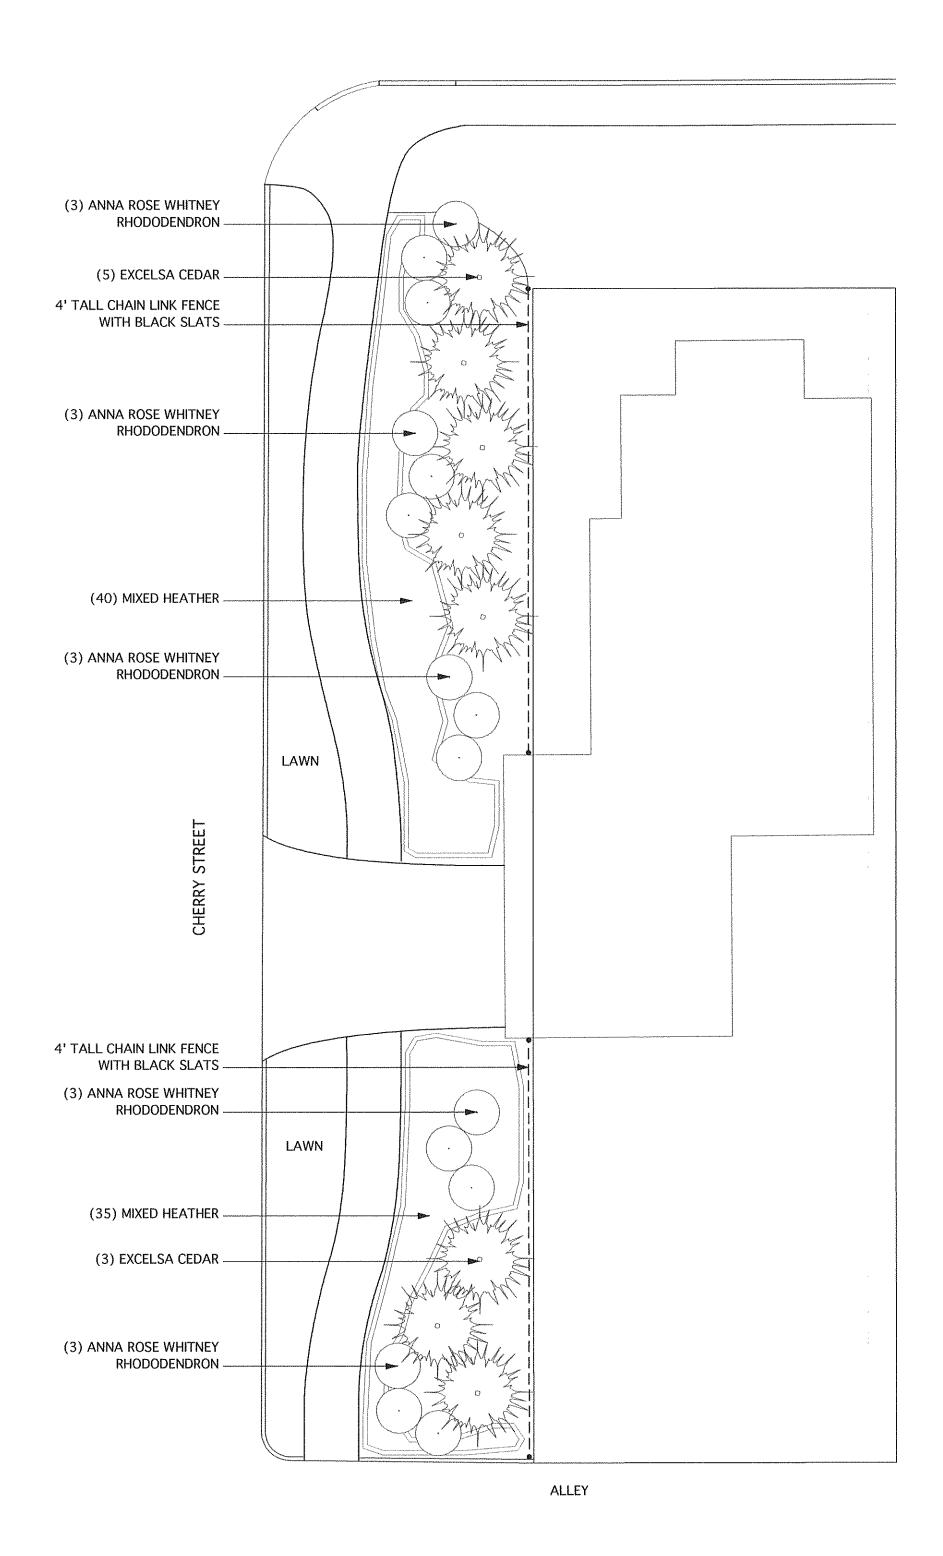


Cherry Street West Detail

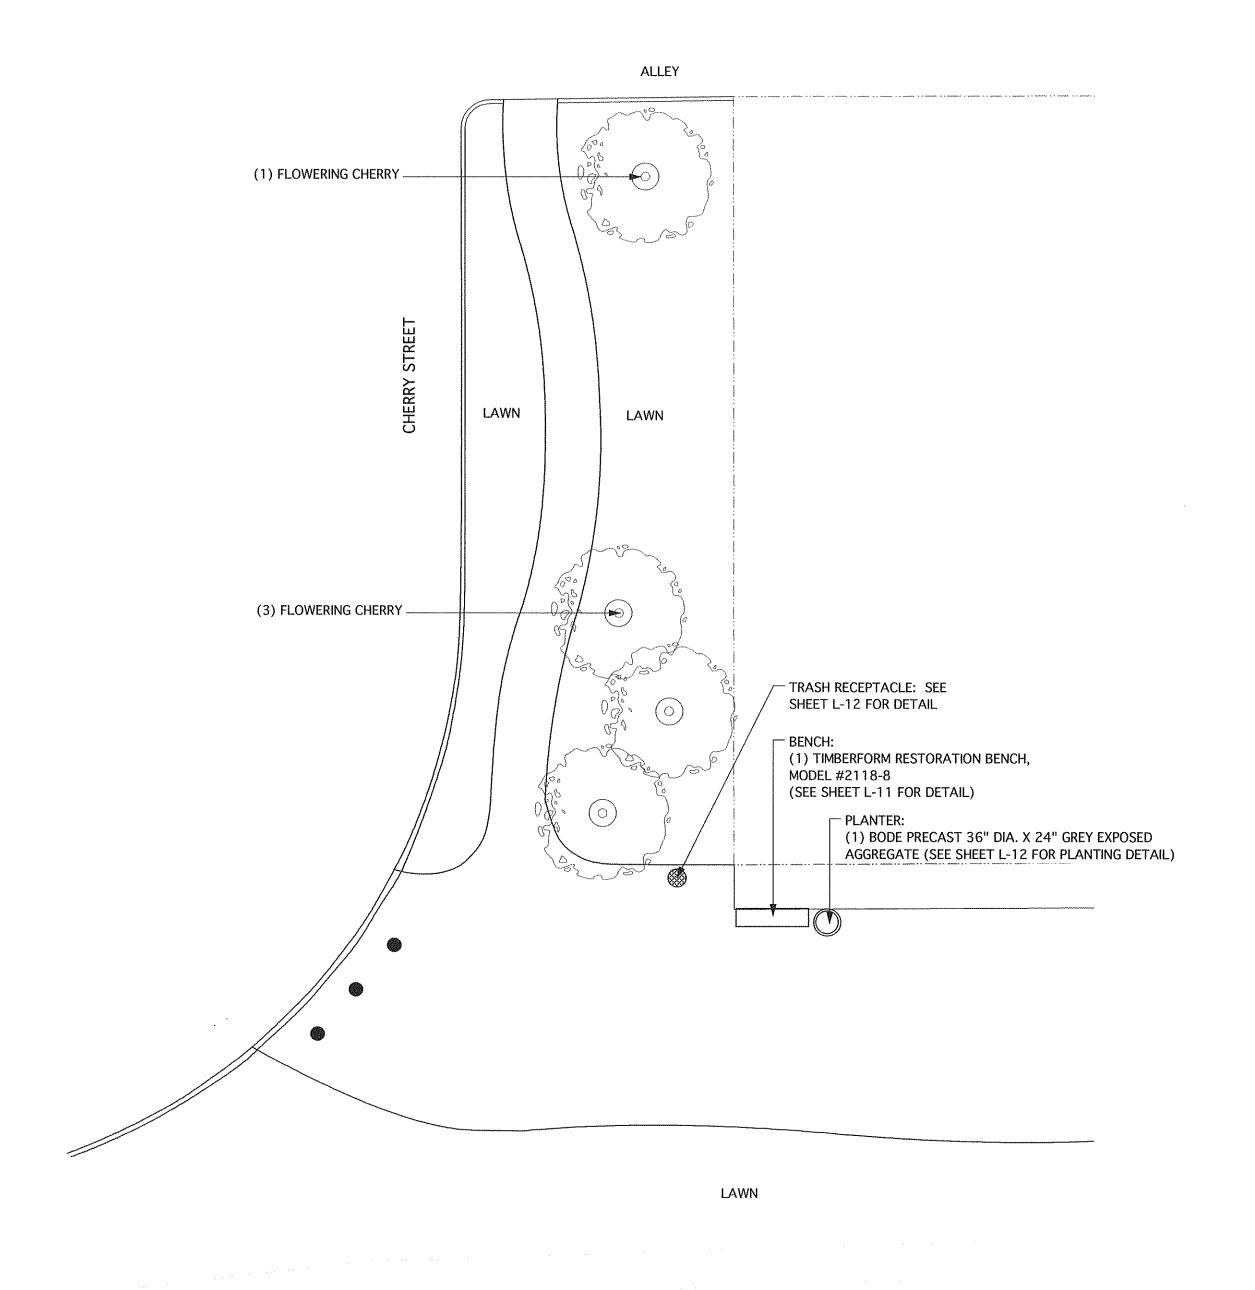

Cherry Street East Detail

Cherry Street Planting Plan
Scale: 1" = 10'-0"

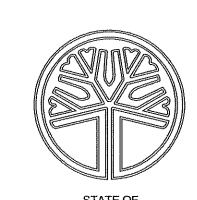

STATE OF WASHINGTON REGISTERED LANDSCAPE ARCHITECT

> PAUL M. GEORGE CERTIFICATE NO. 641



P.O. Box 5938 Bellingham, WA 98227 360-715-2119

cgroup@cascadedesigngroup.net


Paul George Landscape Architect

Contendale, WA Walk


REVISIONS


May 1, 2007

DATE: March 9, 2007

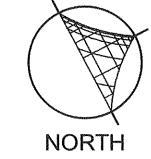

NORTH L-5

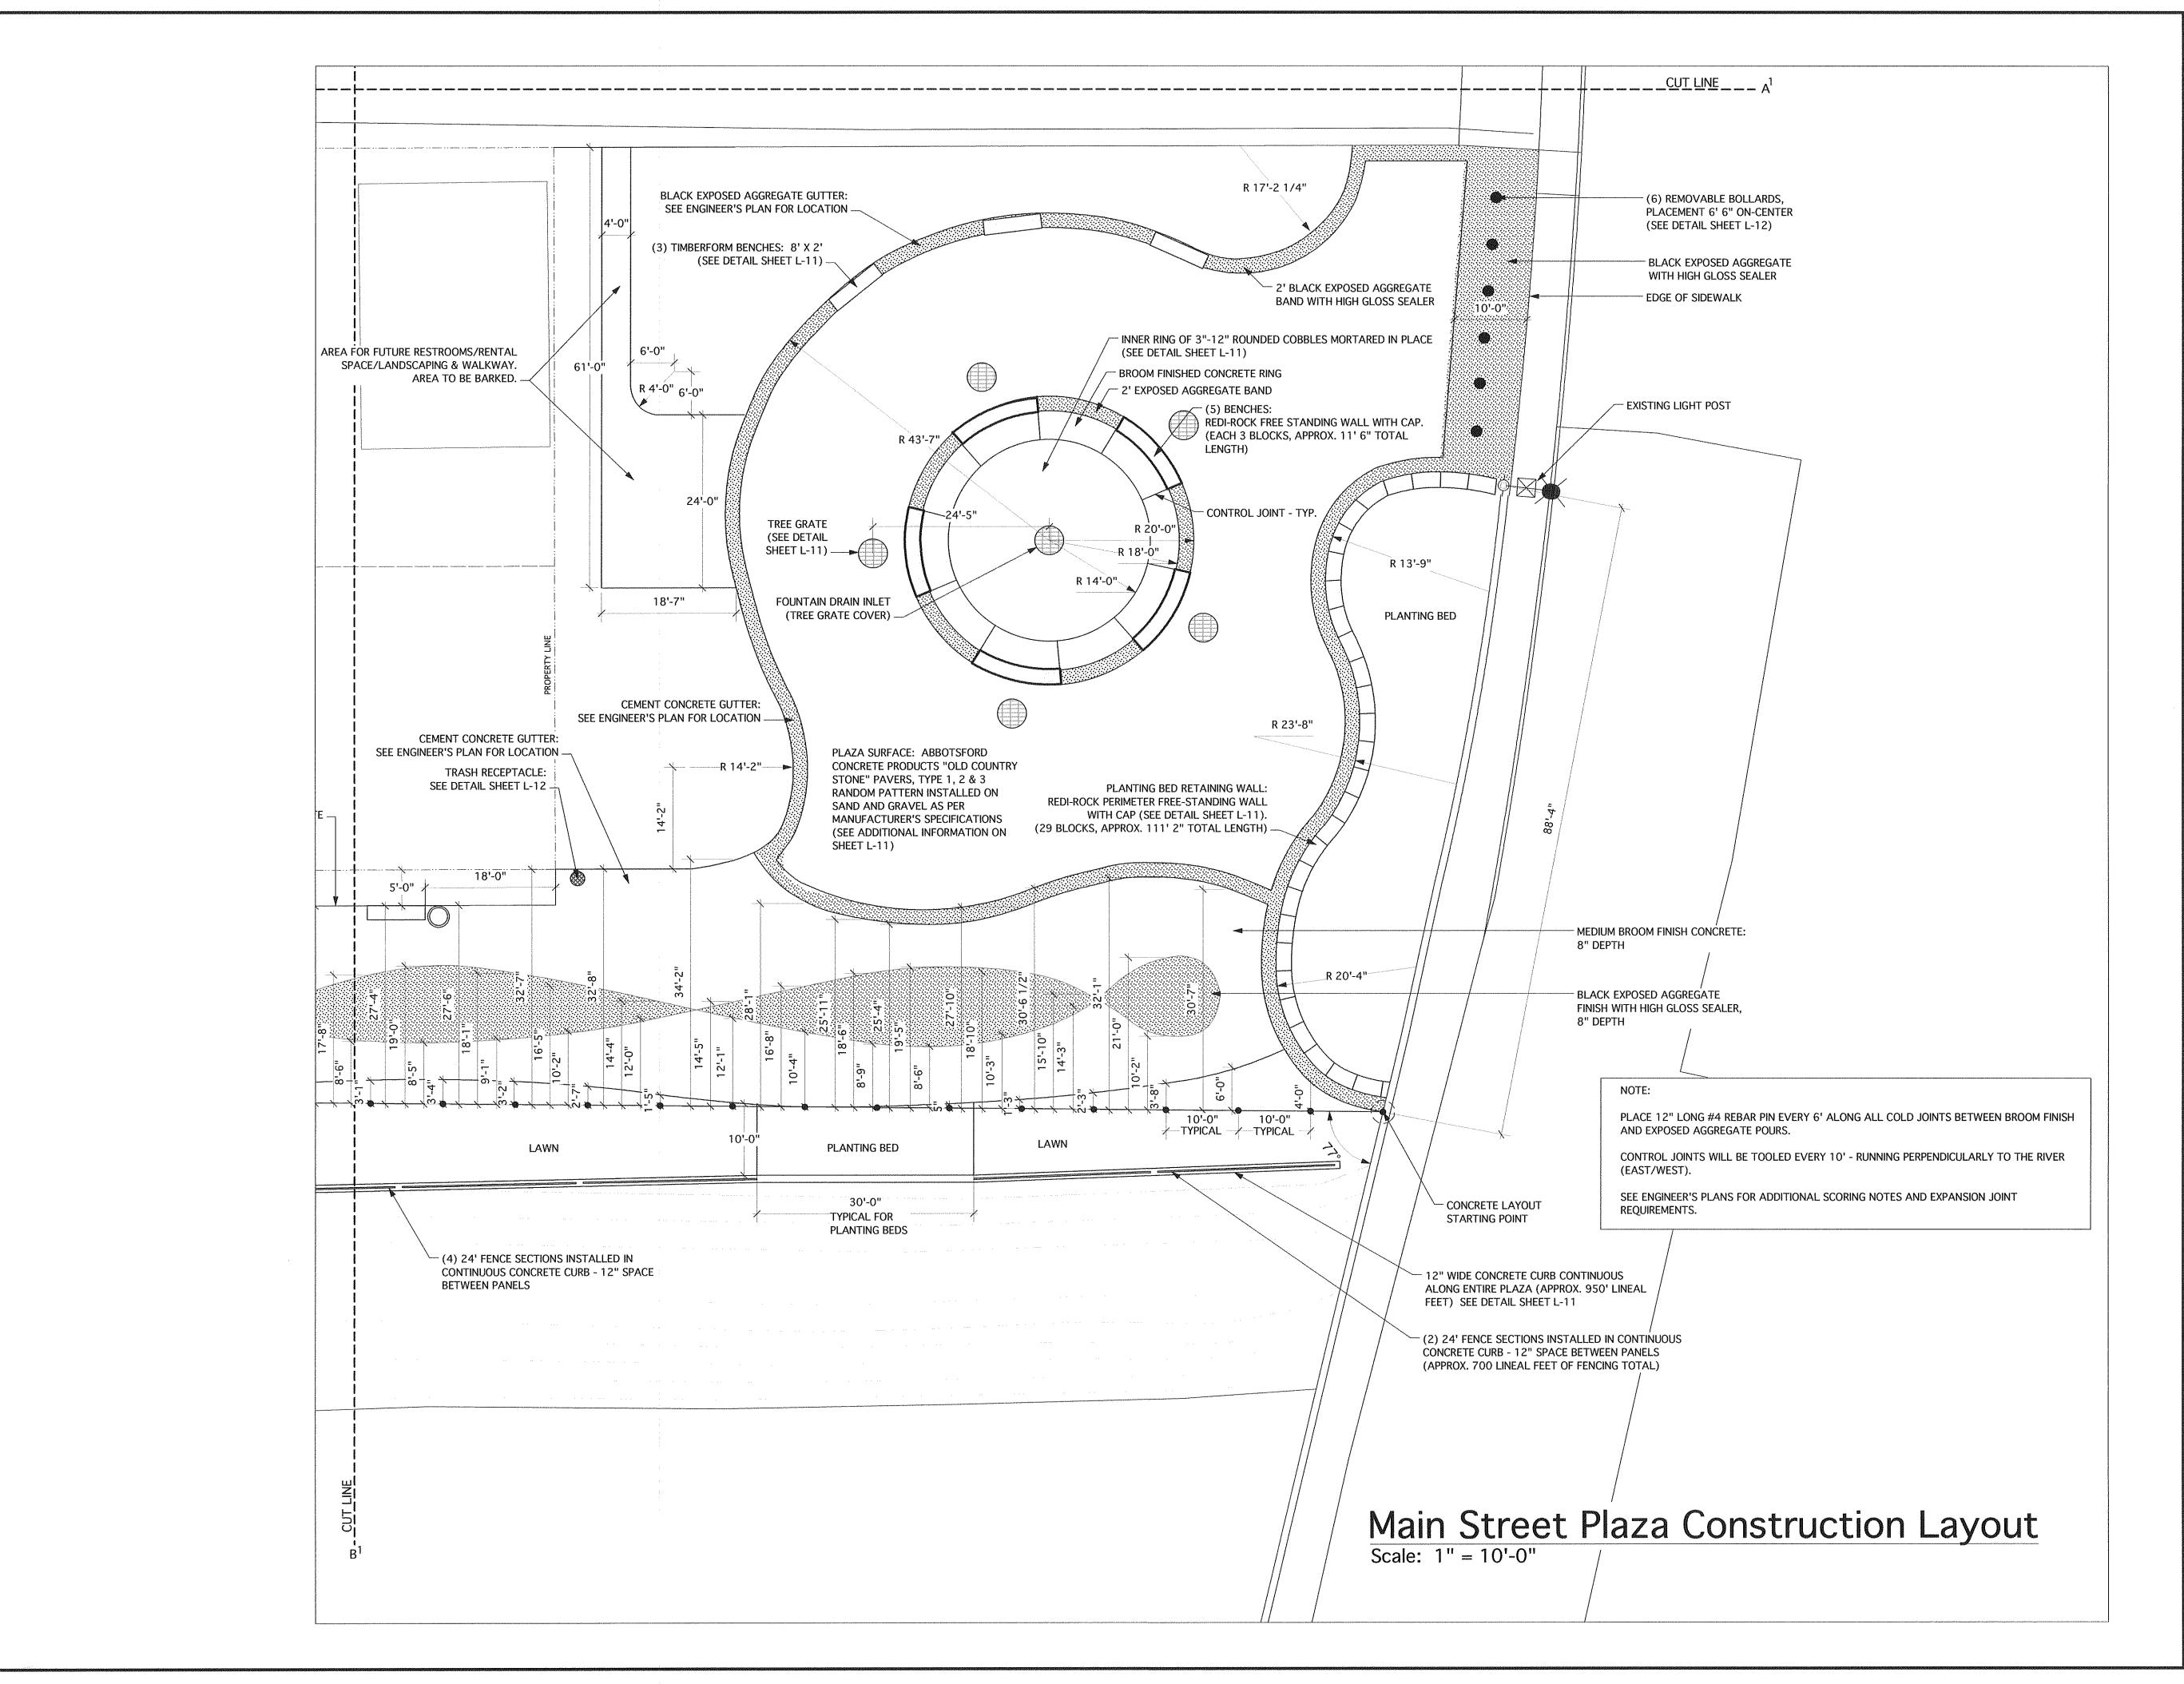

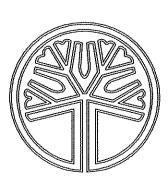

STATE OF WASHINGTON REGISTERED LANDSCAPE ARCHITECT

PAUL M. GEORGE CERTIFICATE NO. 641



Cascade Design Group

P.O. Box 5938 Bellingham, WA 98227 360-715-2119

cgroup@cascadedesigngroup.net


Paul George Landscape Architect

> Z S S Centennial Femdale


REVISIONS


May 1, 2007


DATE: March 9, 2007

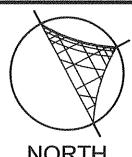


NORTH

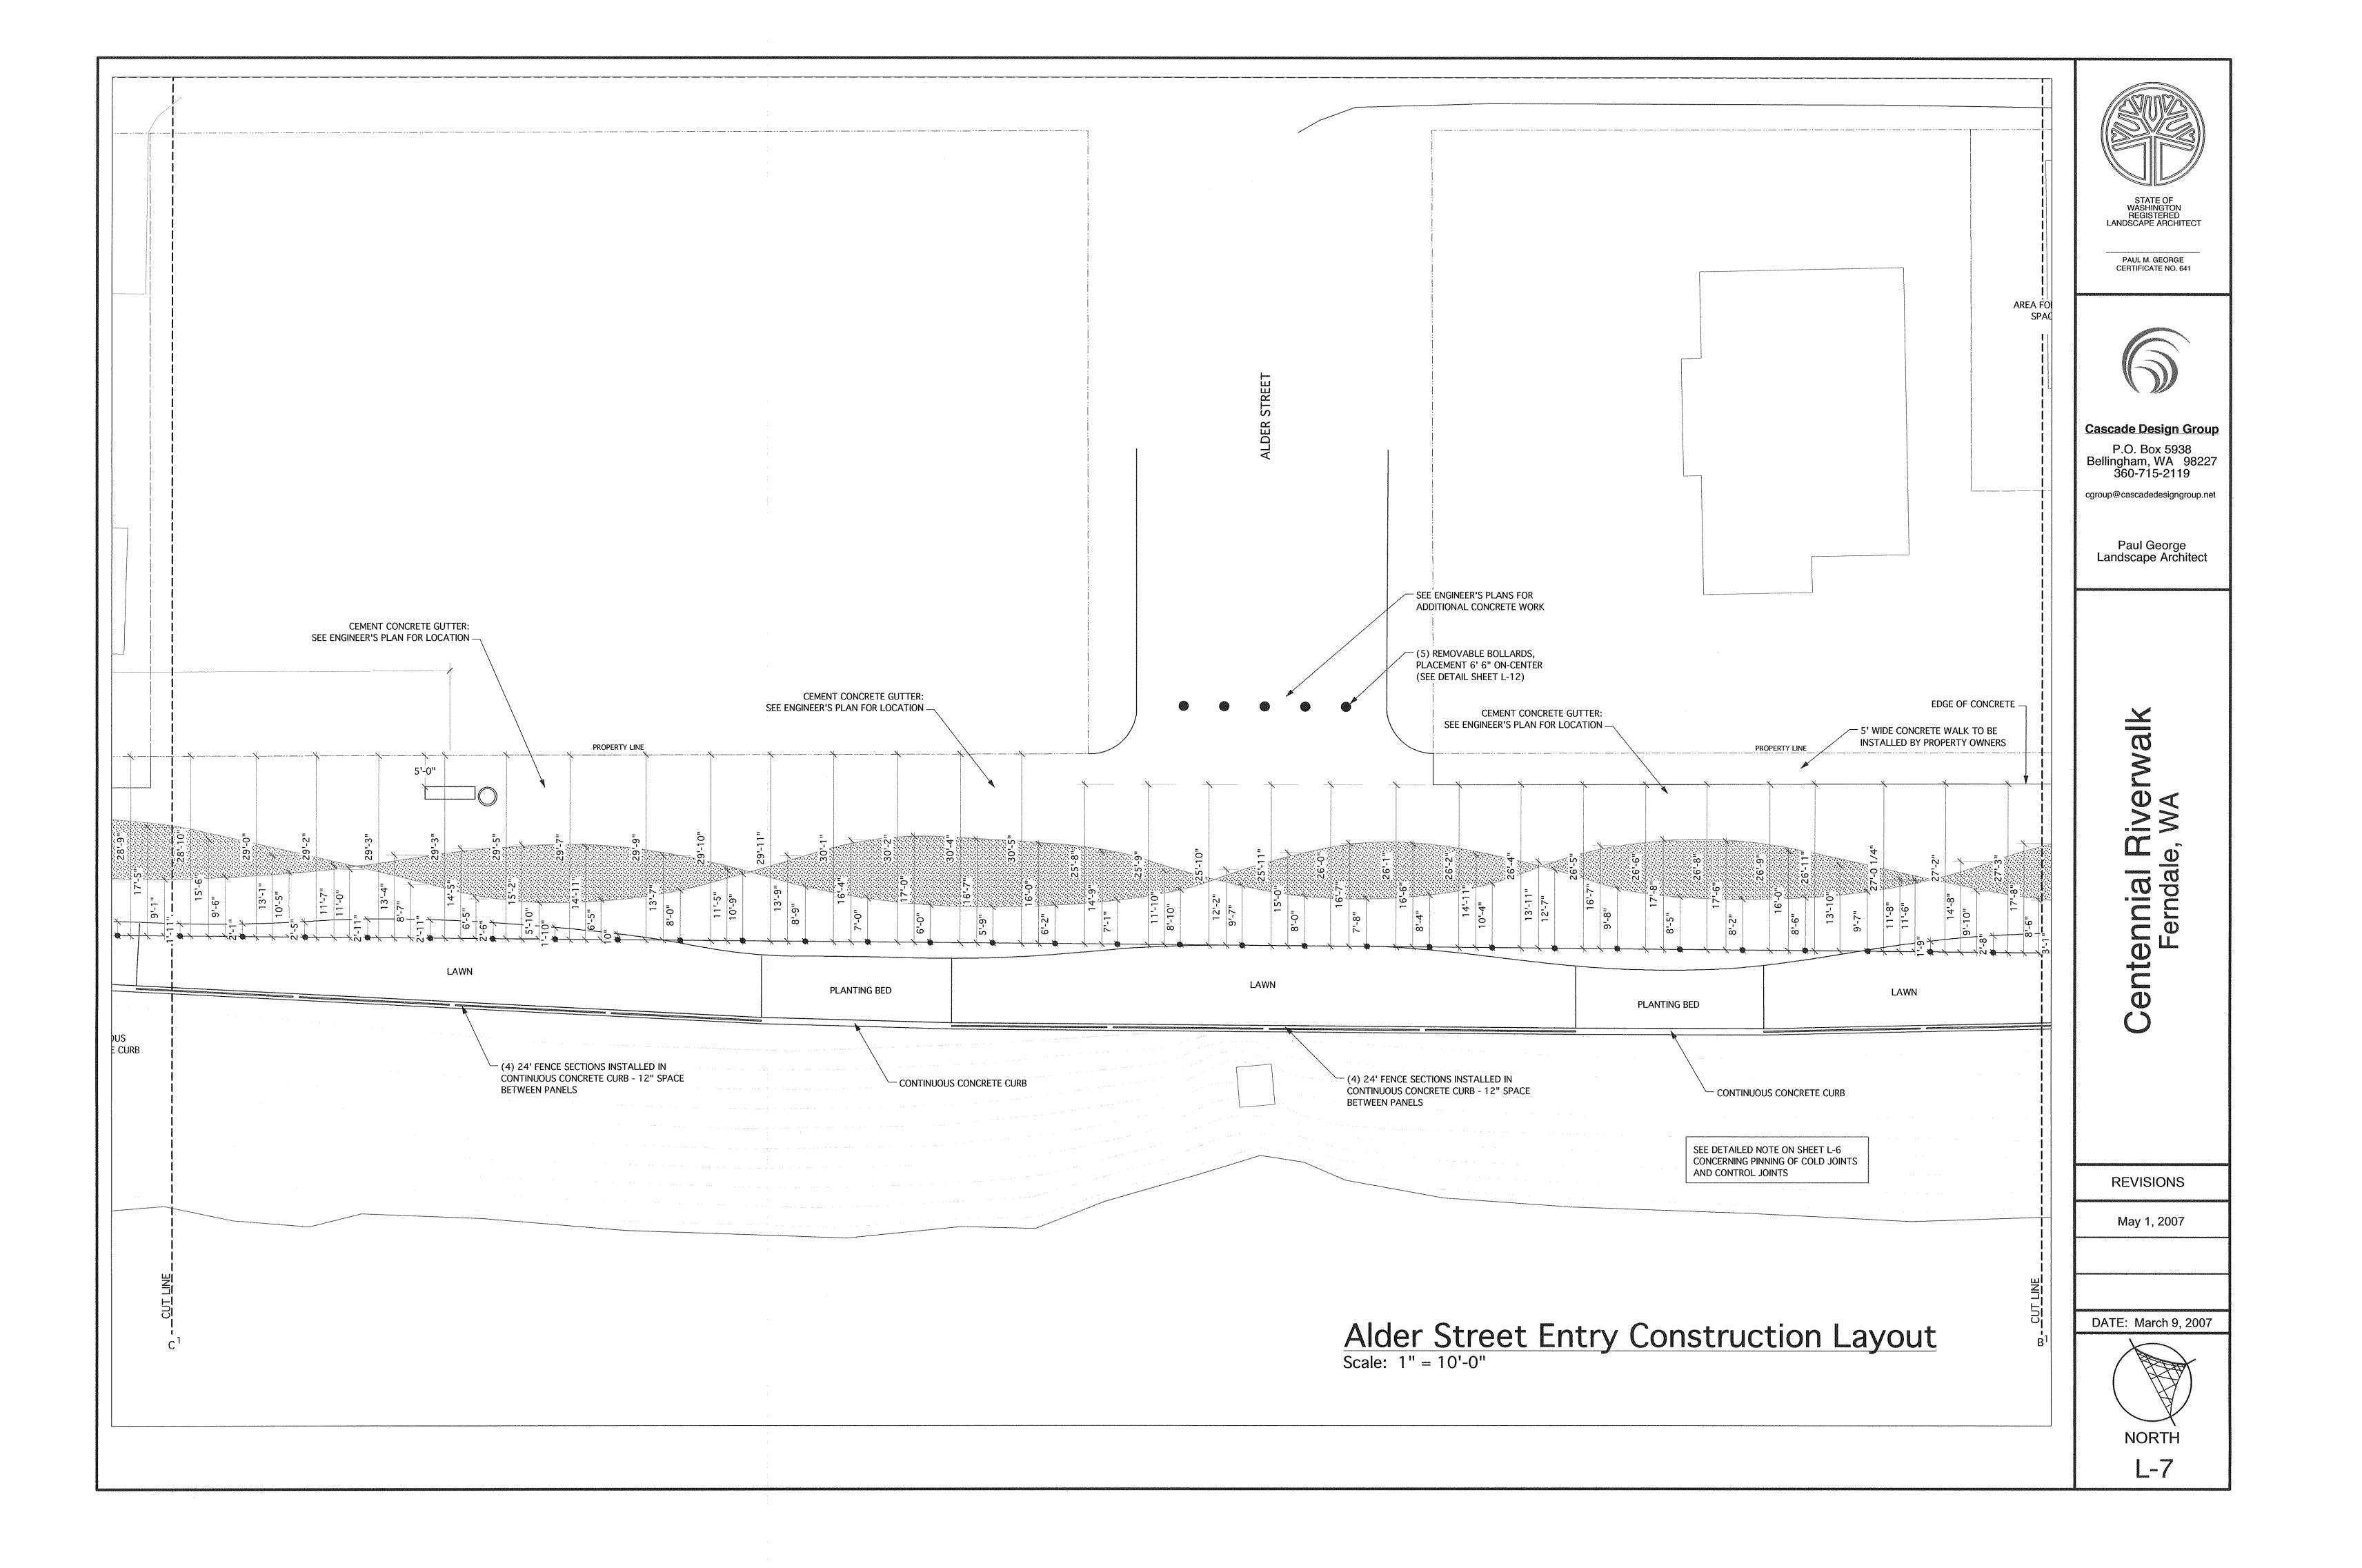

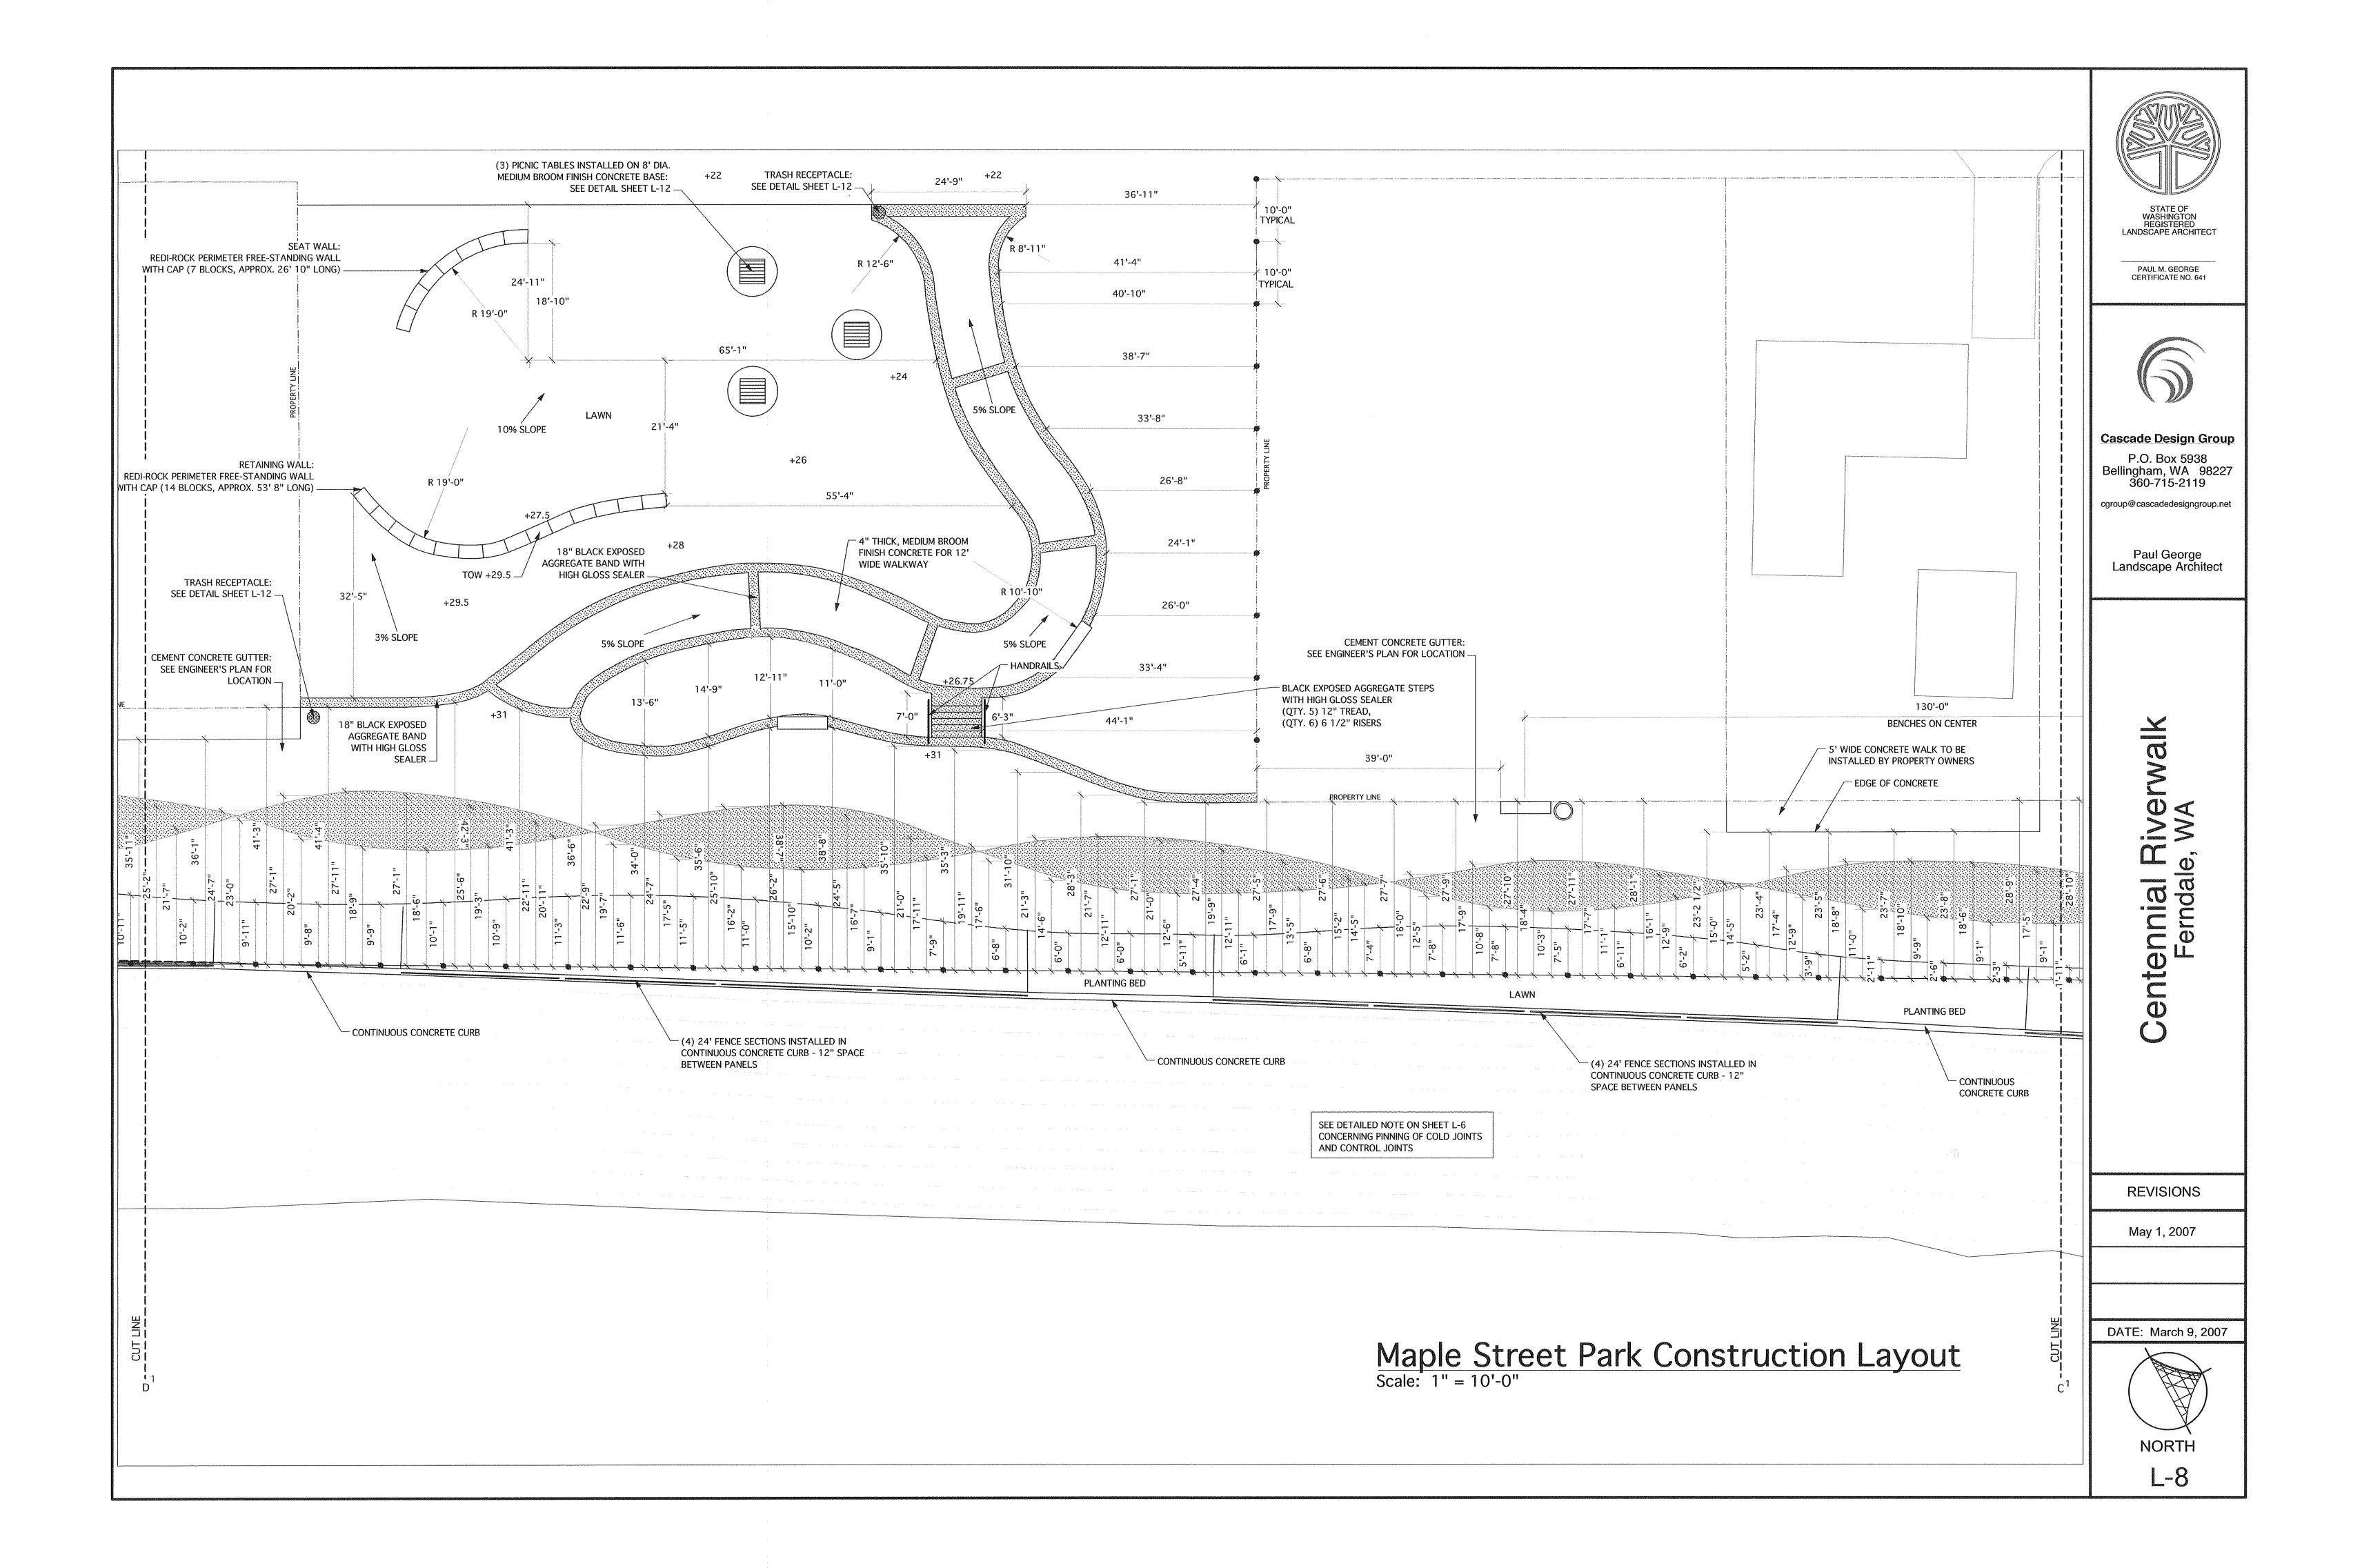

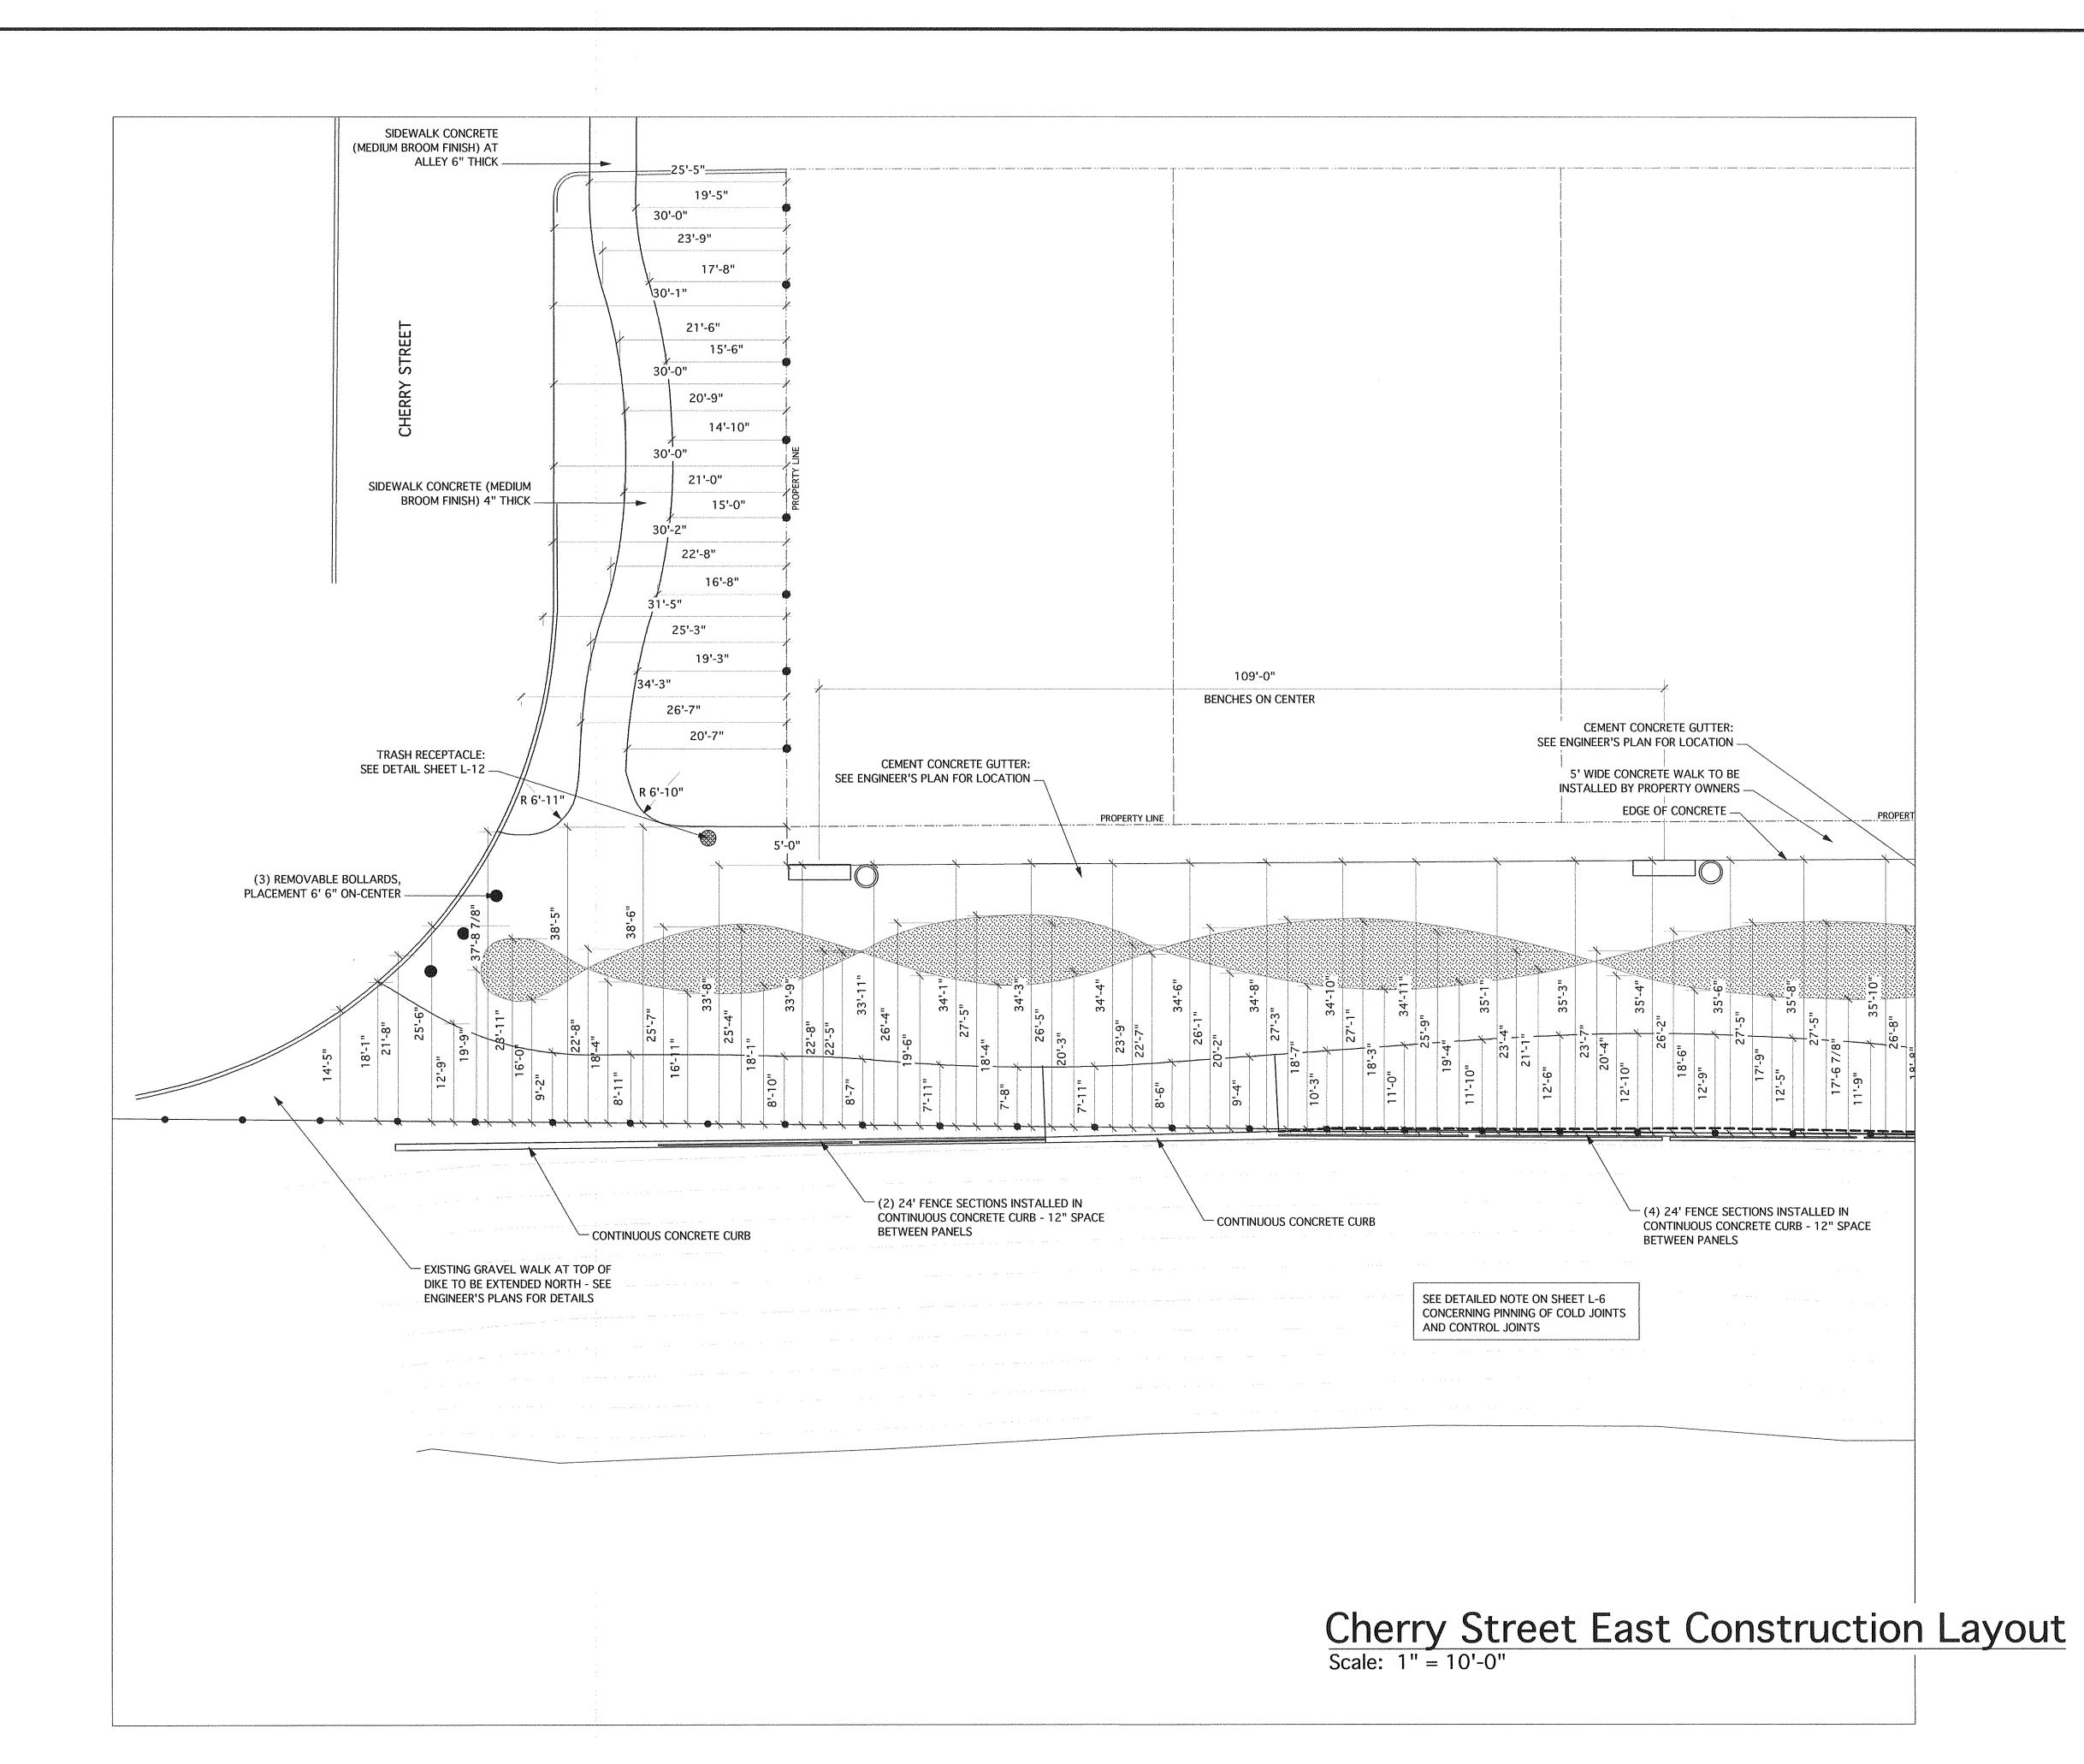

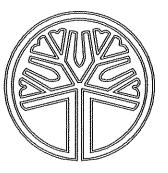

STATE OF WASHINGTON REGISTERED LANDSCAPE ARCHITECT

> PAUL M. GEORGE CERTIFICATE NO. 641



P.O. Box 5938 Bellingham, WA 98227 360-715-2119

cgroup@cascadedesigngroup.net


Paul George Landscape Architect

Centernal Designation of the Sale of the S

REVISIONS


May 1, 2007

DATE: March 9, 2007

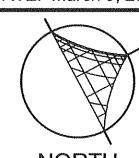


NORTH

L-9

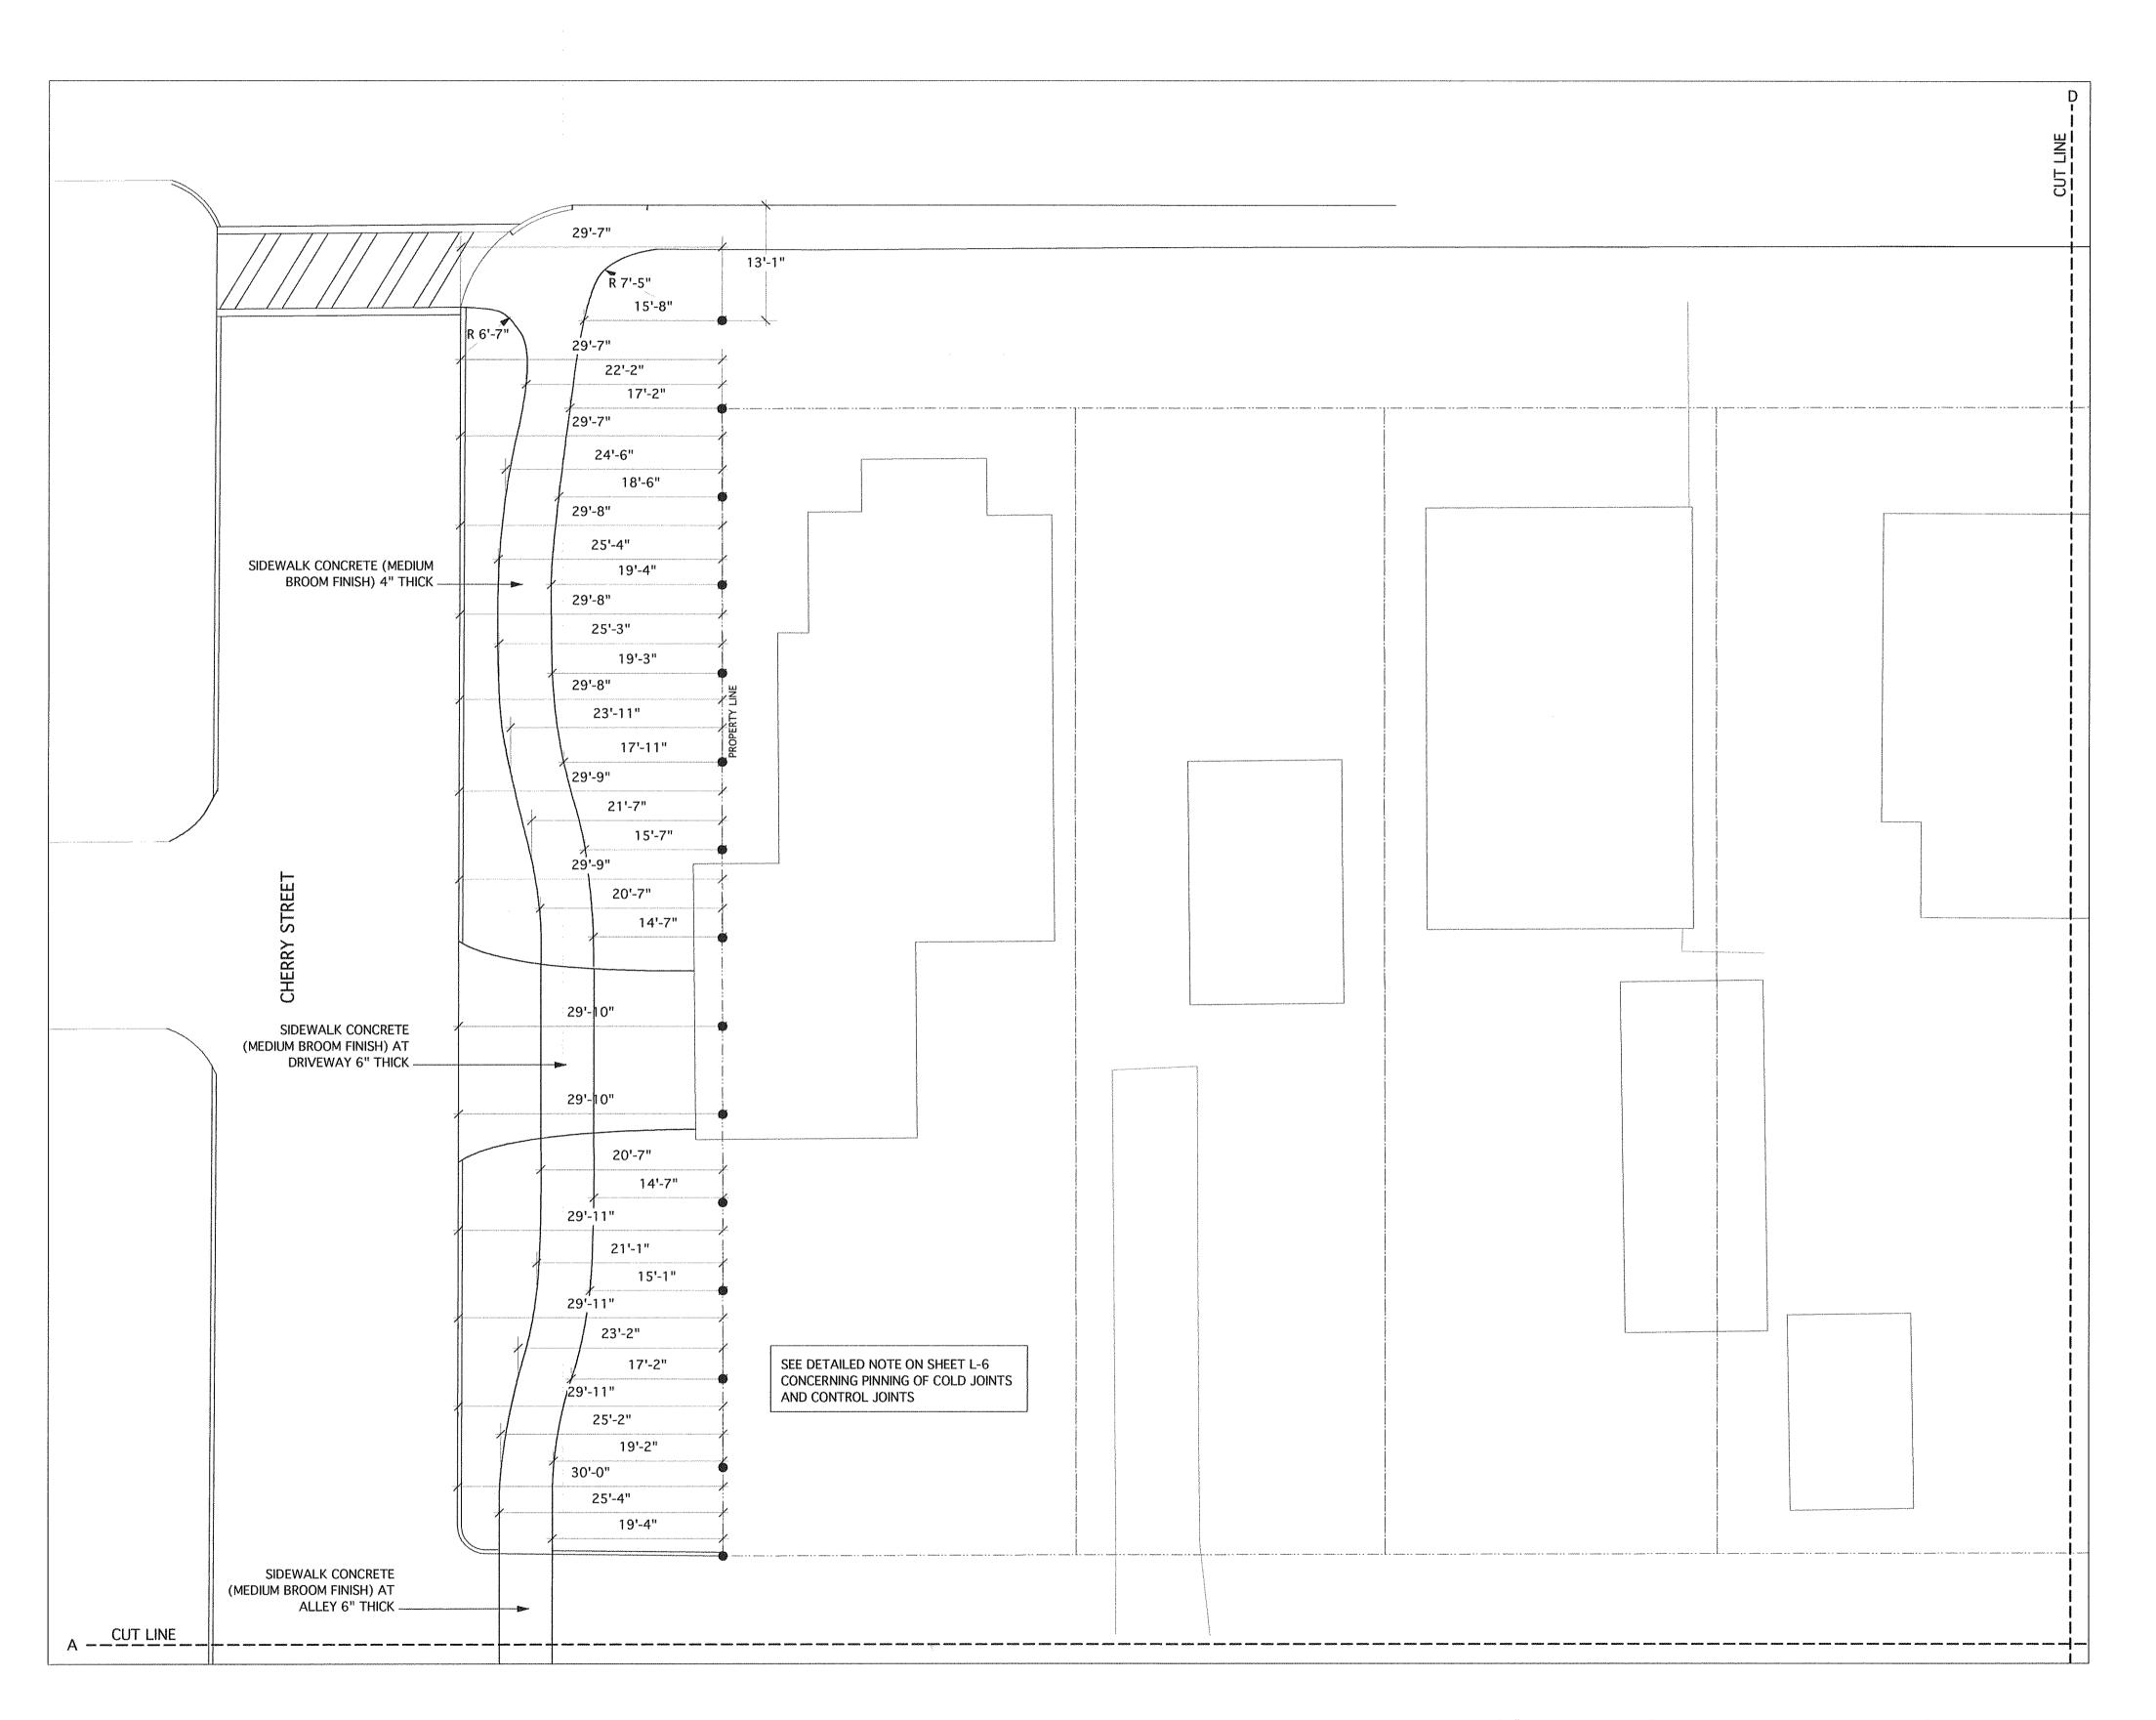

Cherry Street West Construction Layout
Scale: 1" = 10'-0"

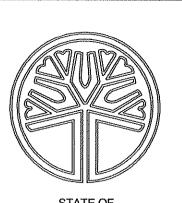

STATE OF WASHINGTON REGISTERED LANDSCAPE ARCHITECT

> PAUL M. GEORGE CERTIFICATE NO. 641



P.O. Box 5938
Bellingham, WA 98227
360-715-2119


cgroup@cascadedesigngroup.net

Paul George Landscape Architect

REVISIONS

May 1, 2007

DATE: March 9, 2007

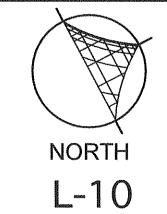

SITE FURNISHINGS:

BENCH: (QTY. 24) TIMBERFORM
RESTORATION
MODEL #2118-8
YELLOW CEDAR SLATS
BLACK FINISH

WWW.TIMBERFORM.COM

LITTER RECEPTACLE: (QTY. 4) TIMBERFORM

MODEL #2772-DT-P DOME-TOP, PEDESTAL MOUNTING WWW.TIMBERFORM.COM

TABLES: (QTY. 3) TIMBERFORM

MODEL #2056-8484-P

WWW.TIMBERFORM.COM

BOLLARDS: (QTY. 14) TIMBERFORM
TIMBER BOLLARD
MODEL #2563-R
36" HEIGHT - LATHE TURNED
WWW.TIMBERFORM.COM

CONCRETE PLANTERS: (QTY. 19) BODES PRECAST

ROUND PLANTER
EXPOSED AGGREGATE FINISH
36" DIAMETER/24" HEIGHT
WWW.BODESPRECAST.COM

TREE GRATES: (QTY. 6) URBAN ACCESSORIES
SANSKRIT
4' DIAMETER/ROUND

WWW.URBANACCESSORIES.COM

SEAT/RETAINING WALLS: (APPROX. 250 LINEAL FEET) REDI-ROCK FREE STANDING WALL BLOCKS WITH CAPS WWW.REDI-ROCK.COM/BODE'S PRECAST


PAVERS: ABBOTSFORD CONCRETE PRODUCTS
OLD COUNTRY STONE

WWW.PAVINGSTONES.COM


OLD COUNTRY STONE
TYPE 1, 2 & 3 RANDOM PATTERN
TYPE 1 COMPRISES 50% OF TOTAL AREA (COLOR: CHARCOAL)
TYPE 2 COMPRISES 34% OF TOTAL AREA (COLOR: NATURAL)
TYPE 3 COMPRISES 16% OF TOTAL AREA (COLOR: RED/BLACK)

NOTE FOR CONTRACTORS:


ALL MEASUREMENTS AND QUANTITIES MUST BE VERIFIED BY THE CONTRACTOR PRIOR TO INSTALLATION & ANY/ ALL DISCREPANCIES BROUGHT TO THE ATTENTION OF THE LANDSCAPE ARCHITECT. NO SUBSTITUTIONS SHALL BE MADE WITHOUT THE AUTHORIZATION OF THE LANDSCAPE ARCHITECT.

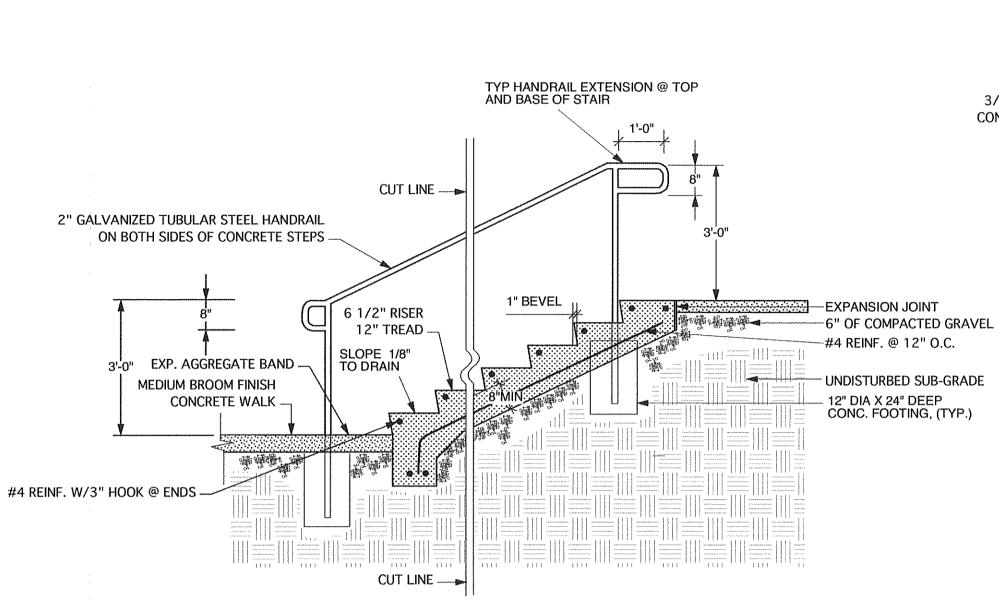

Stair & Handrail Detail

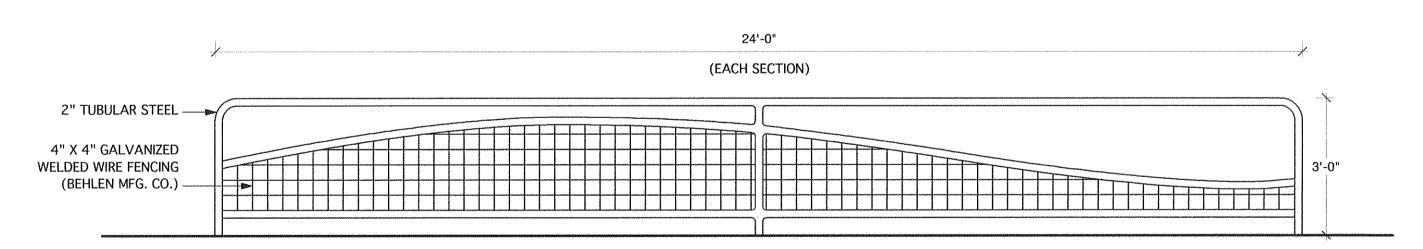


Riverside Fence Detail
Scale: 1/2" = 1'-0"

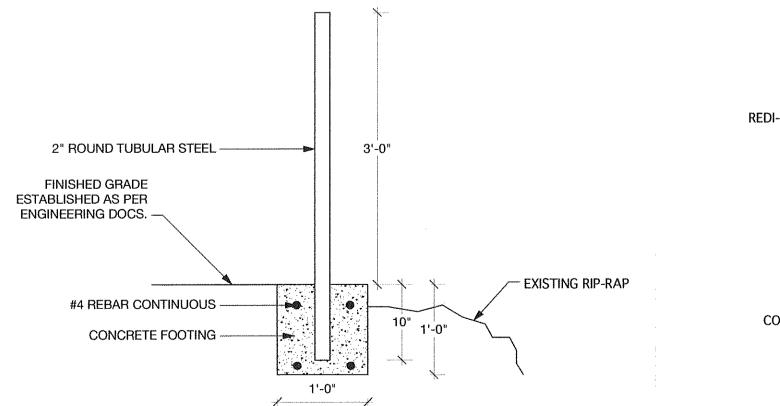


Riverside Fence Construction Detail


Scale: 1/2" = 1'-0"

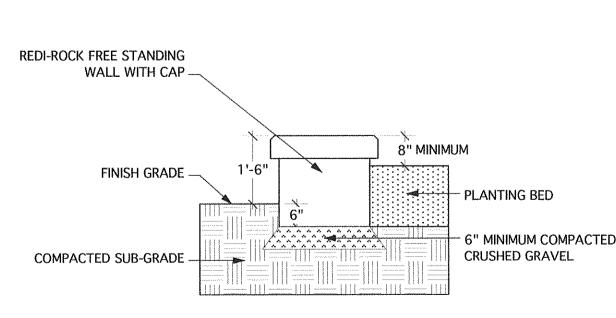

Redi-Rock Wall Detail
Scale: 1" = 1'-0"

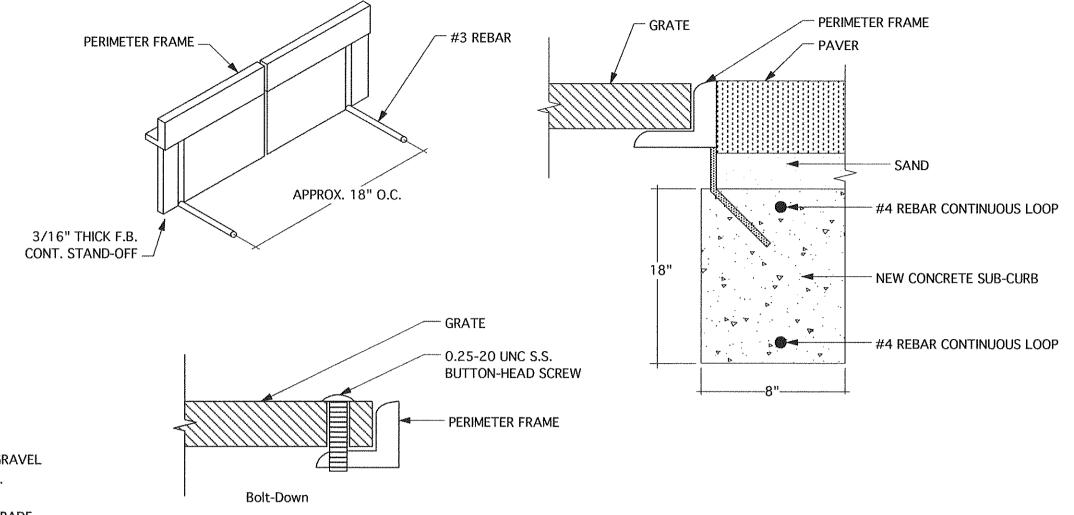

Tree Grate Details
Scale: NTS

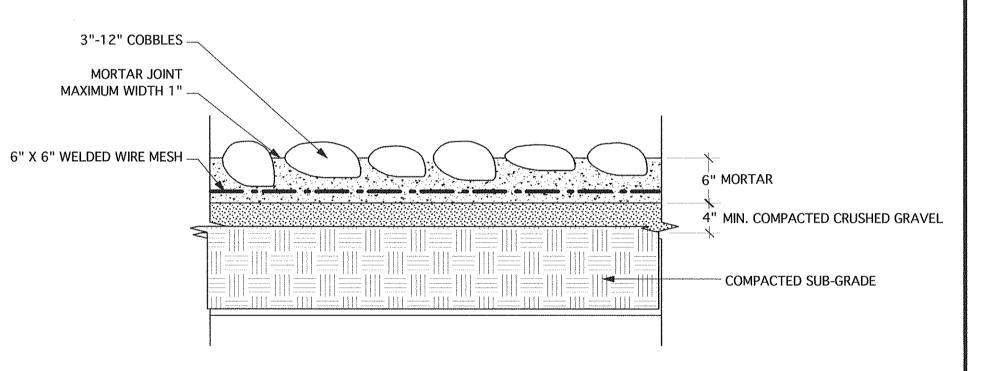


Mortared Cobble Detail
Scale: 1" =1'-0"

4", 6" OR 8" MIN. CONCRETE SLAB AS INDICATED ON PLAN -4", 6" OR 8" MIN. COMPACTED CRUSHED GRAVEL AS INDICATED ON ENGINEER'S PLAN -COMPACTED SUB-GRADE CONCRETE SCORING NOTE: -EXPANSION JOINTS AND CONTROL JOINTS WILL BE INCLUDED PER INDUSTRY STANDARD (SEE ENGINEER'S SPECS. FOR ADDITIONAL INFORMATION). -CONTROL JOINTS SHOULD PENETRATE TO A Concrete Walkway Detail (Typical) DEPTH EQUAL TO 25% OF SLAB THICKNESS. Scale: 1" = 1'-0" -SCORING DETAILS, LAYOUT AND PATTERN ARE TO BE CONFIRMED BETWEEN THE CONCRETE CONTRACTOR AND LANDSCAPE ARCHITECT PRIOR TO INSTALLATION.

Site Furnishings & Landscape Construction Details

Scale: As Indicated

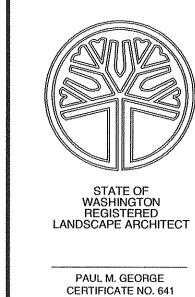



P.O. Box 5938 Bellingham, WA 98227 360-715-2119

cgroup@cascadedesigngroup.net

Paul George Landscape Architect


> Centennial Riverwalk Ferndale, WA

REVISIONS

May 1, 2007

DATE: March 9, 2007

-

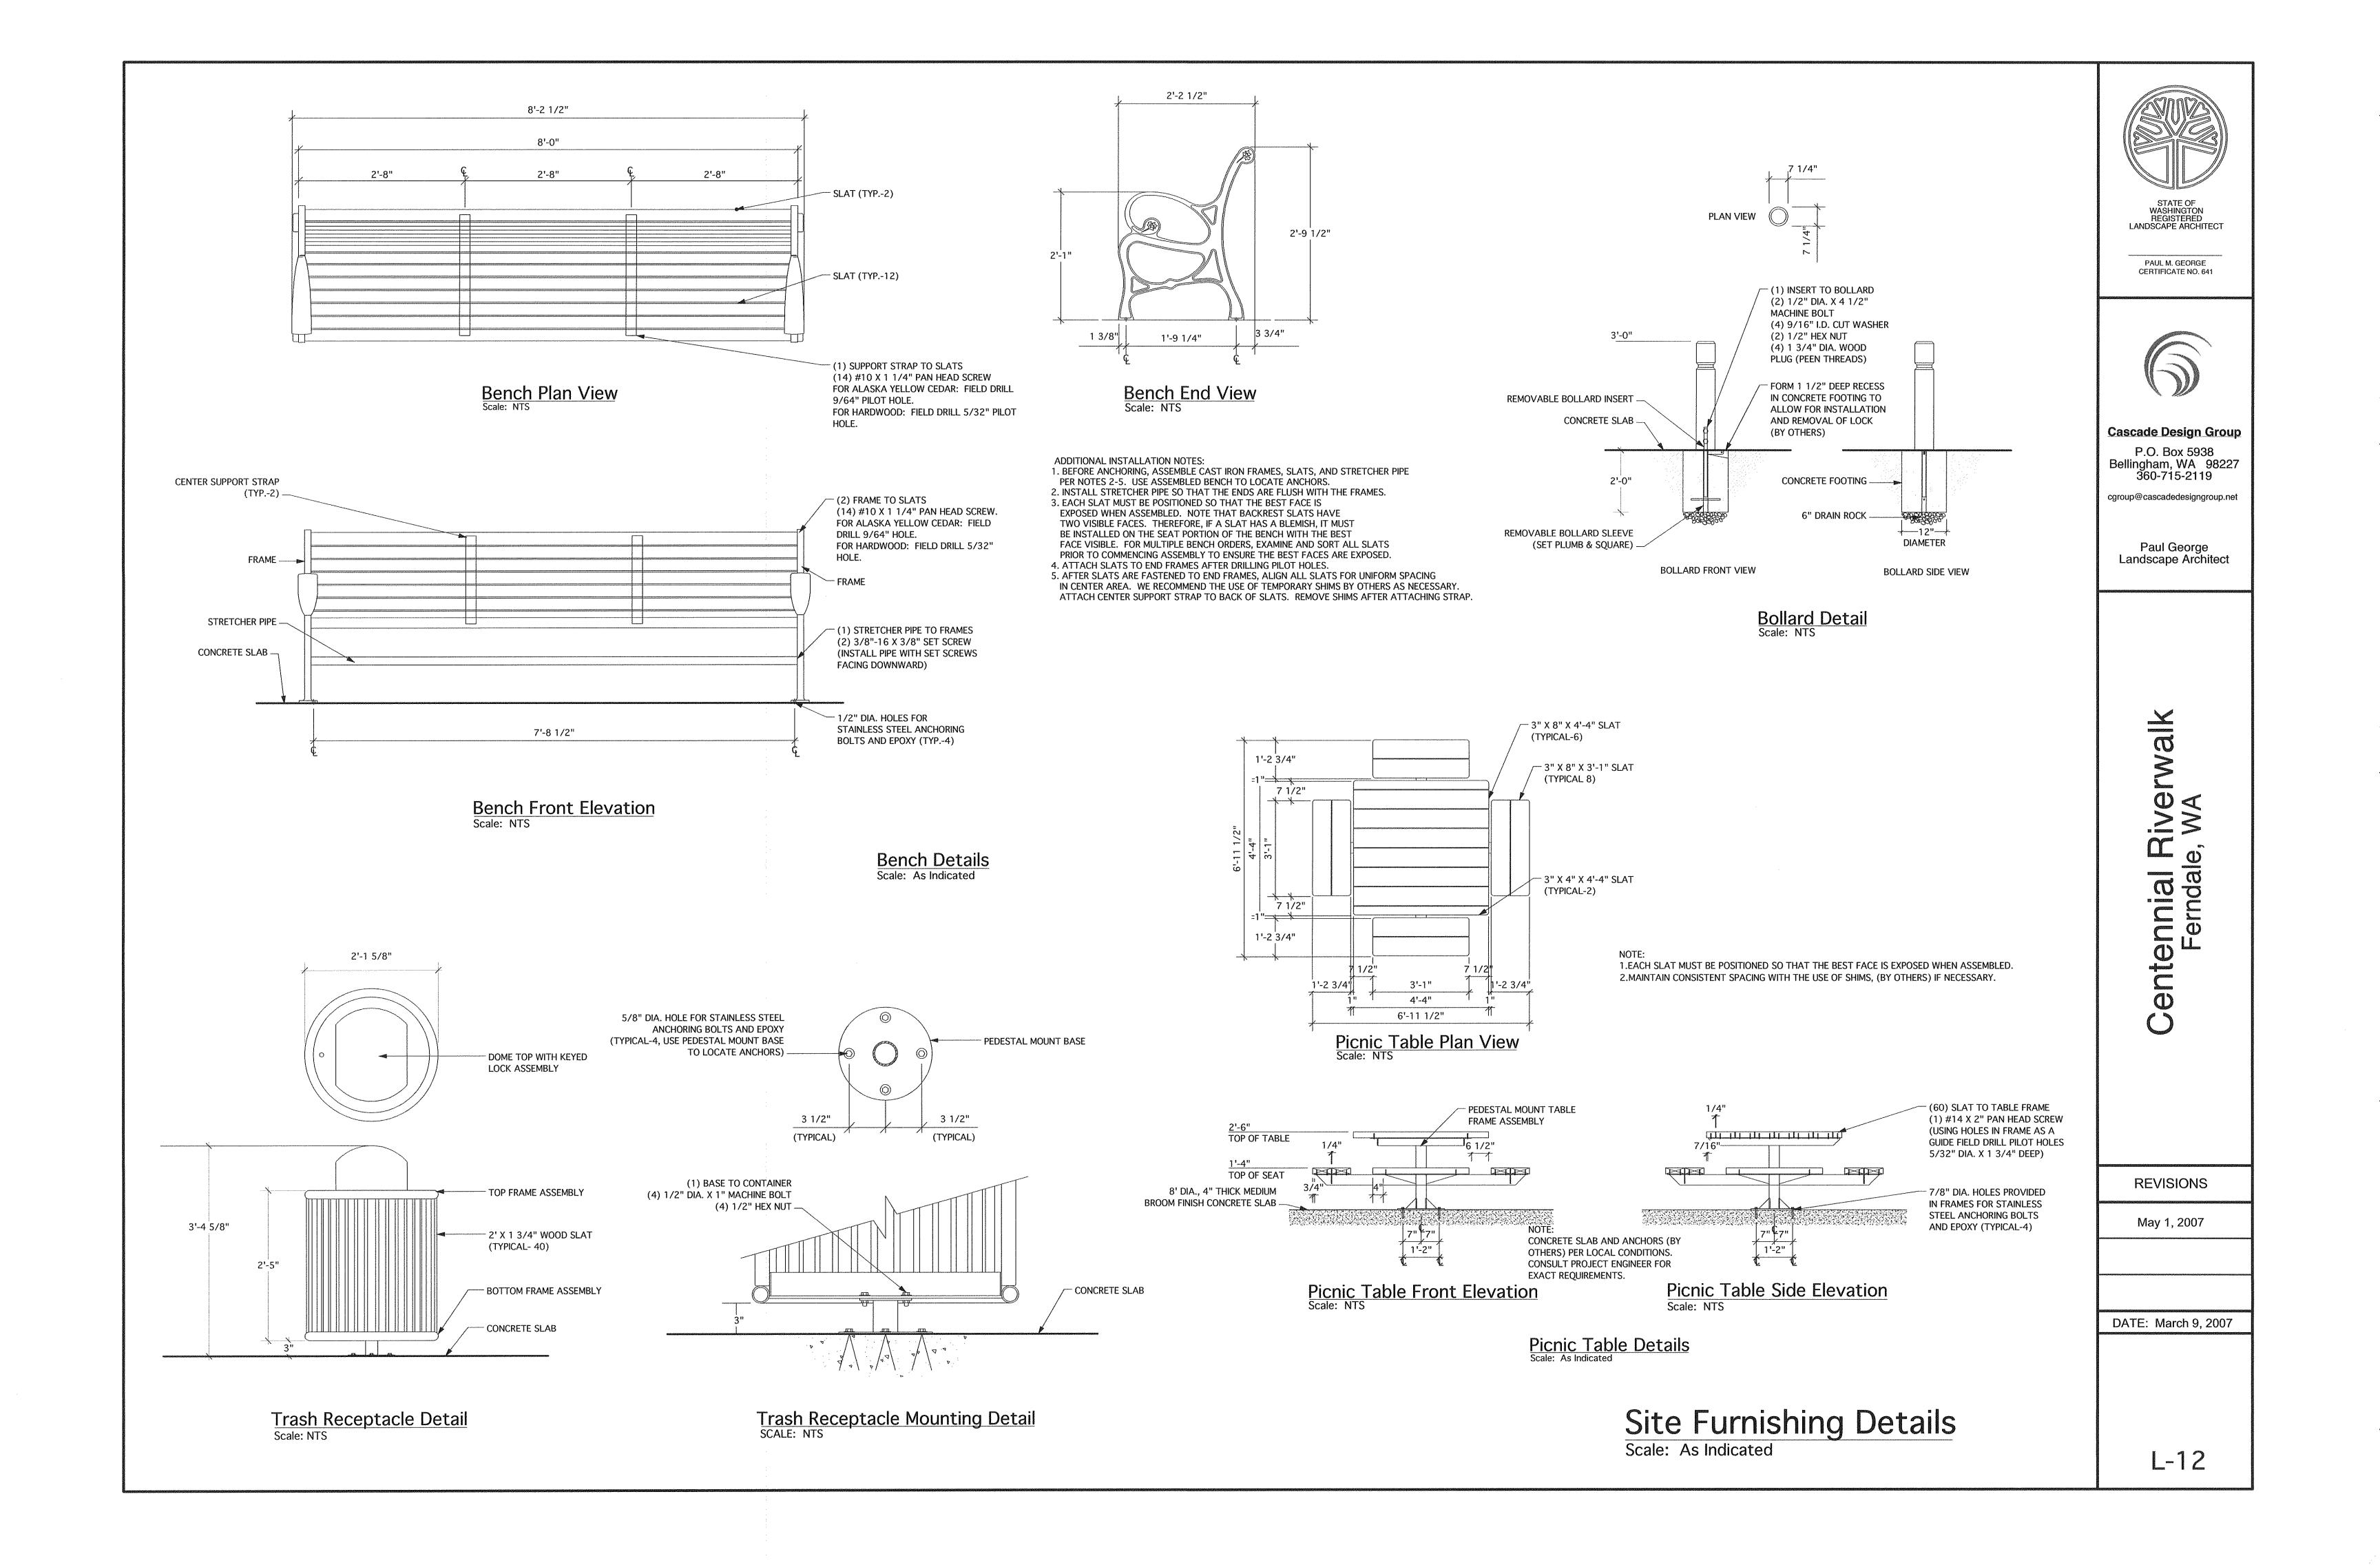


PLANT LIST


ΣΤΥ.	SCIENTIFIC NAME	COMMON NAME	SIZE & SPACING
	TREES		
6	Acer circinatum	Vine Maple	1 1/2" caliper, multi-stem
5	Acer palmatum 'Beni Kawa'	Beni Kawa Japanese Maple	1 1/2" caliper
<u> </u>	Thuja plicata 'Excelsa'	Excelsa Cedar	8-10' basket, 10' o.c.
37	Thuja occidentalis smaragd 'Emerald Green'	Emerald Green Arborvitae	5-6' B&B, 3' o.c.
<u>37</u> 3	Cedrus deodara	Deodar Cedar	8-10' basket
		Japanese Spruce	25' specimen
1 14	Picea jezoensis		1 1/2" caliper
	Crataegus viridis 'Winter King' Cornus kousa 'Satomi'	Winter King Hawthorn Pink Japanese Dogwood	1 1/2" caliper
8	Gleditsia triacanthos	· · ·	1 1/2 caliper 1 1/2" caliper
4	~	Honey Locust	1 1/2" caliper 15' o.c.
3	Fraxinus oxycarpa 'Raywood' Prunus serrulata 'Kwanzan'	Raywood Ash	
4		Kwanzan Flowering Cherry	1 1/2" caliper, 15' o.c.
1	Sequoiadendron giganteum	Giant Redwood	8-10' basket
	SHRUBS		
86	Erica darleyensis 'Mediterranean White'	Mediterranean White Heather	1 gal. pot, 3' o.c.
87	Erica darleyensis 'Mediterranean Pink'	Mediterranean Pink Heather	1 gal. pot, 3' o.c.
87	Erica darleyensis 'Kramer's Red'	Kramer's Red Heather	1 gal. pot, 3' o.c.
77	Rosa woodsii	Wood's Rose	5 gal. pot, 4' o.c.
73	Pinus mugo pumilio	Dwarf Mugo Pine	24-30", 3' o.c.
33	Cornus sericea 'Kelseyi'	Dwarf Dogwood	5 gal. pot
<u> </u>	Mahonia aquifolium 'Compacta'	Compact Oregon Grape Holly	5 gal. pot, 3' o.c.
8	Symphoricarpos albus	Common Snowberry	5 gal. pot, 4' o.c.
3	Cotoneaster lacteus	Parney's Red Clusterberry	5 gal. pot, 8' o.c.
13	Rhododendron 'Taurus'	Taurus Rhododendron	5 gal. pot, 4' o.c.
6	Rhododendron 'Unique Marmalade'	'Unique Marmalade' Rhododendron	5 gal. pot, 4' o.c.
5	Rhododendron 'Lord Roberts'	Lord Roberts Rhododendron	5 gal. pot, 4' o.c.
8	Rhododendron 'Hallelujah'	Hallelujah Rhododendron	5 gal. pot, 4' o.c.
-0	Rhododendron 'Pink Pearl'	Pink Pearl Rhododendron	5 gal. pot, 1' o.c.
3	Rhododendron 'Pink Walloper'	Pink Walloper Rhododendron	5 gal. pot, 1' o.c.
 5	Rhododendron 'Anna Kruschke'	Anna Kruschke Rhododendron	5 gal. pot, 6 o.c.
15	Rhododendron 'Anna Rose Whitney'	Anna Rose Whitney Rhododendron	5 gal. pot, 4' o.c.
	PERENNIALS & GROUNDCOVERS		
437	Gaultheria shallon	Salal	1 gal. pot, 3' o.c.
50	Vinca minor 'Atropurpurea'	Wine Periwinkle	1 gal. pot, 3' o.c.
19	Arctostaphylos uva-ursi 'Vancouver Jade'	Vancouver Jade Kinnikinnick	1 gal. pot for containers
19	Huechera x brizoides 'Firefly'	Firefly Coral Bells	1 gal. pot for containers
95	Hemerocallis 'Stella de Oro'	Stella de Oro Daylily	1 gal. pot, 2' o.c.
91	Coreopsis verticillata 'Zagreb'	Zagreb Threadleaf Coreopsis	1 gal. pot, 18" o.c.
30	Crocosmia 'Lucifer'	Lucifer Crocosmia	1 gal. pot, 18" o.c.
100	Scabiosa columbaria 'Butterfly Blue'	Butterfly Blue Pincushion Flower	1 gal. pot, 15" o.c.
17	Salvia 'May Night'	May Night Sage	1 gal. pot, 2' o.c.
13	Bergenia cordifolia	Heart Leaf Bergenia	1 gal. pot, 2' o.c.
	EEDNIC CDASSES & EMEDIENTS		
1Ω	FERNS, GRASSES & EMERGENTS Polyetichum munitum	Sword Fern	1 gal. pot, 3' o.c.
<u>18</u>	Polystichum munitum		
32	Calamagrostis x acutiflora 'Karl Foerster'	Foerster's Feather Reed Grass	1 gal. pot, 2' o.c.
23	Carex obnupta	Slough Sedge	1 gal pot
24	Juncus effusus	Common Rush	1 gal. pot
120	Tiarella trifoliata	Foamflower	1 gal. pot, 2' o.c.
120	Aquilegia formosa	Western Columbine	1 gal. pot, 2' o.c.
120	Iris douglasiana	Pacific Coast Iris	1 gal. pot, 2' o.c.
5	Phygelius capensis	Cape Fuchsia	5 gal. pot, 3' o.c.
	ANNUALS		
	See Recommendation List on Sheet L-11	Seasonal Color Annuals	Use 1/3 flat of 4" pots per container

RECOMMENDED ANNUALS FOR SEASONAL COLOR


COOL SEASON: WARM SEASON: FLOWERING KALE COCKSCOMB (CELOSIA) FLOWERING CABBAGE COSMOS CORNFLOWER (CENTAUREA CYANUS) **GERANIUM** PRIMROSE (PRIMULA) **IMPATIENS** LOBELIA PANSY (VIOLA) DIANTHUS SWEET ALYSSUM (LOBULARIA MARITIMA) NICOTIANA CHRYSANTHEMUM FORGET-ME-NOT (MYOSOTIS SYLVATICA) PETUNIA CANDYTUFT (IBERIS UMBELLATA) ANNUAL PHLOX (PHLOX DRUMMONDII) PAINTED TONGUE (SALPIGLOSSIS SINUATA) CANTERBURY BELL (CAMPANULA MEDIUM) POT MARIGOLD (CALENDULA OFFICINALIS) SAGE (SALVIA) MARIGOLD (TAGETES) NASTURTIUM (TROPAEOLUM MAJUS) DAHLIA ZINNIA

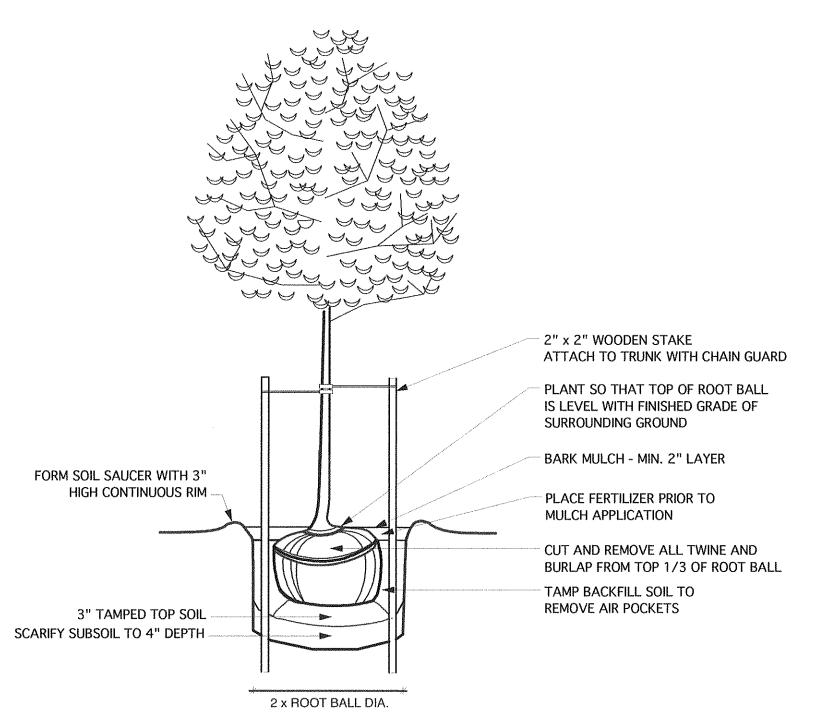


DECIDUOUS TREE PLANTING DETAIL

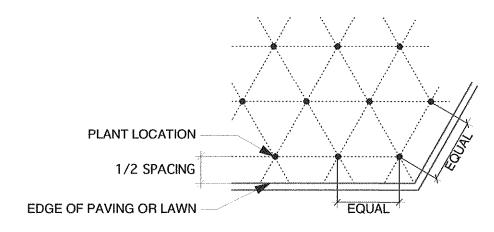


TRIANGULAR SPACING DETAIL

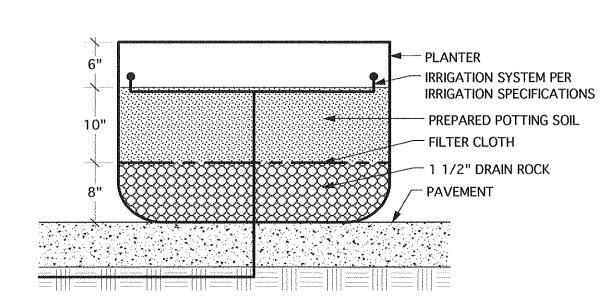


Planter Installation Detail
Scale: 1" = 1'-0"

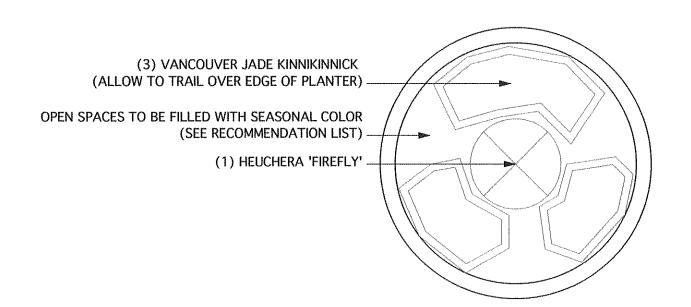


Planter Detail (Typical)
Scale: 1" = 1'-0"

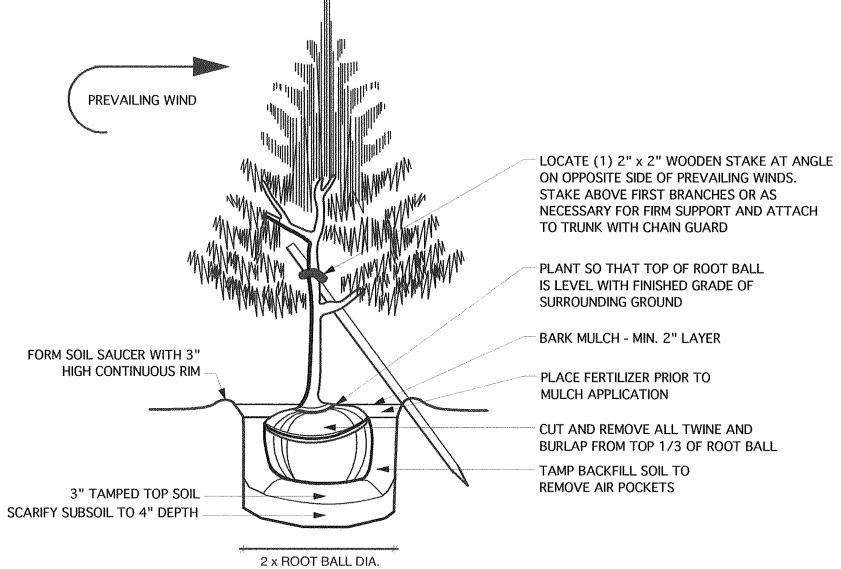

EVERGREEN TREE PLANTING DETAIL

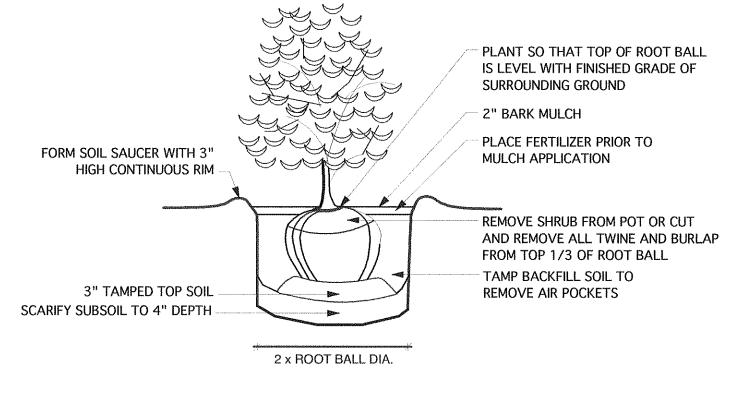

SHRUB PLANTING DETAIL

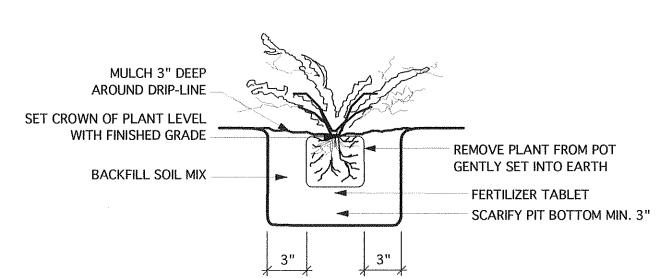

GROUND COVER PLANTING DETAIL

NOTE FOR CONTRACTORS:


ALL PLANT MATERIAL MUST CONFORM TO A.N.L.A. (AMERICAN NURSERY AND LANDSCAPE ASSOCIATION) STANDARDS FOR BOTH PLANT SIZE AND FORM. ALL QUANTITIES MUST BE VERIFIED BY THE CONTRACTOR PRIOR TO INSTALLATION & ANY/ ALL DISCREPANCIES BROUGHT TO THE ATTENTION OF THE LANDSCAPE ARCHITECT. NO SUBSTITUTIONS SHALL BE MADE WITHOUT THE AUTHORIZATION OF THE LANDSCAPE ARCHITECT.

ALL LAWN AREAS WILL RECEIVE 4"-6" PREPARED TOP-SOIL MIX (IN ADDITION TO REQUIRED SOILS SPECIFIED IN PLANTING DETAILS). ALL PLANTING BEDS WILL RECEIVE 8" OF TOPSOIL.

ALL PLANTING BEDS WILL RECEIVE A MINIMUM OF 4" OF MEDIUM BARK MULCH.

Plant List & Details

Scale: As Indicated

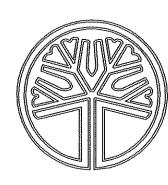

STATE OF WASHINGTON REGISTERED LANDSCAPE ARCHITECT

PAUL M. GEORGE CERTIFICATE NO. 641



Cascade Design Group
P.O. Box 5938

P.O. Box 5938 Bellingham, WA 98227 360-715-2119

cgroup@cascadedesigngroup.net


Paul George Landscape Architect

REVISIONS

May 1, 2007

DATE: March 9, 2007


L-13

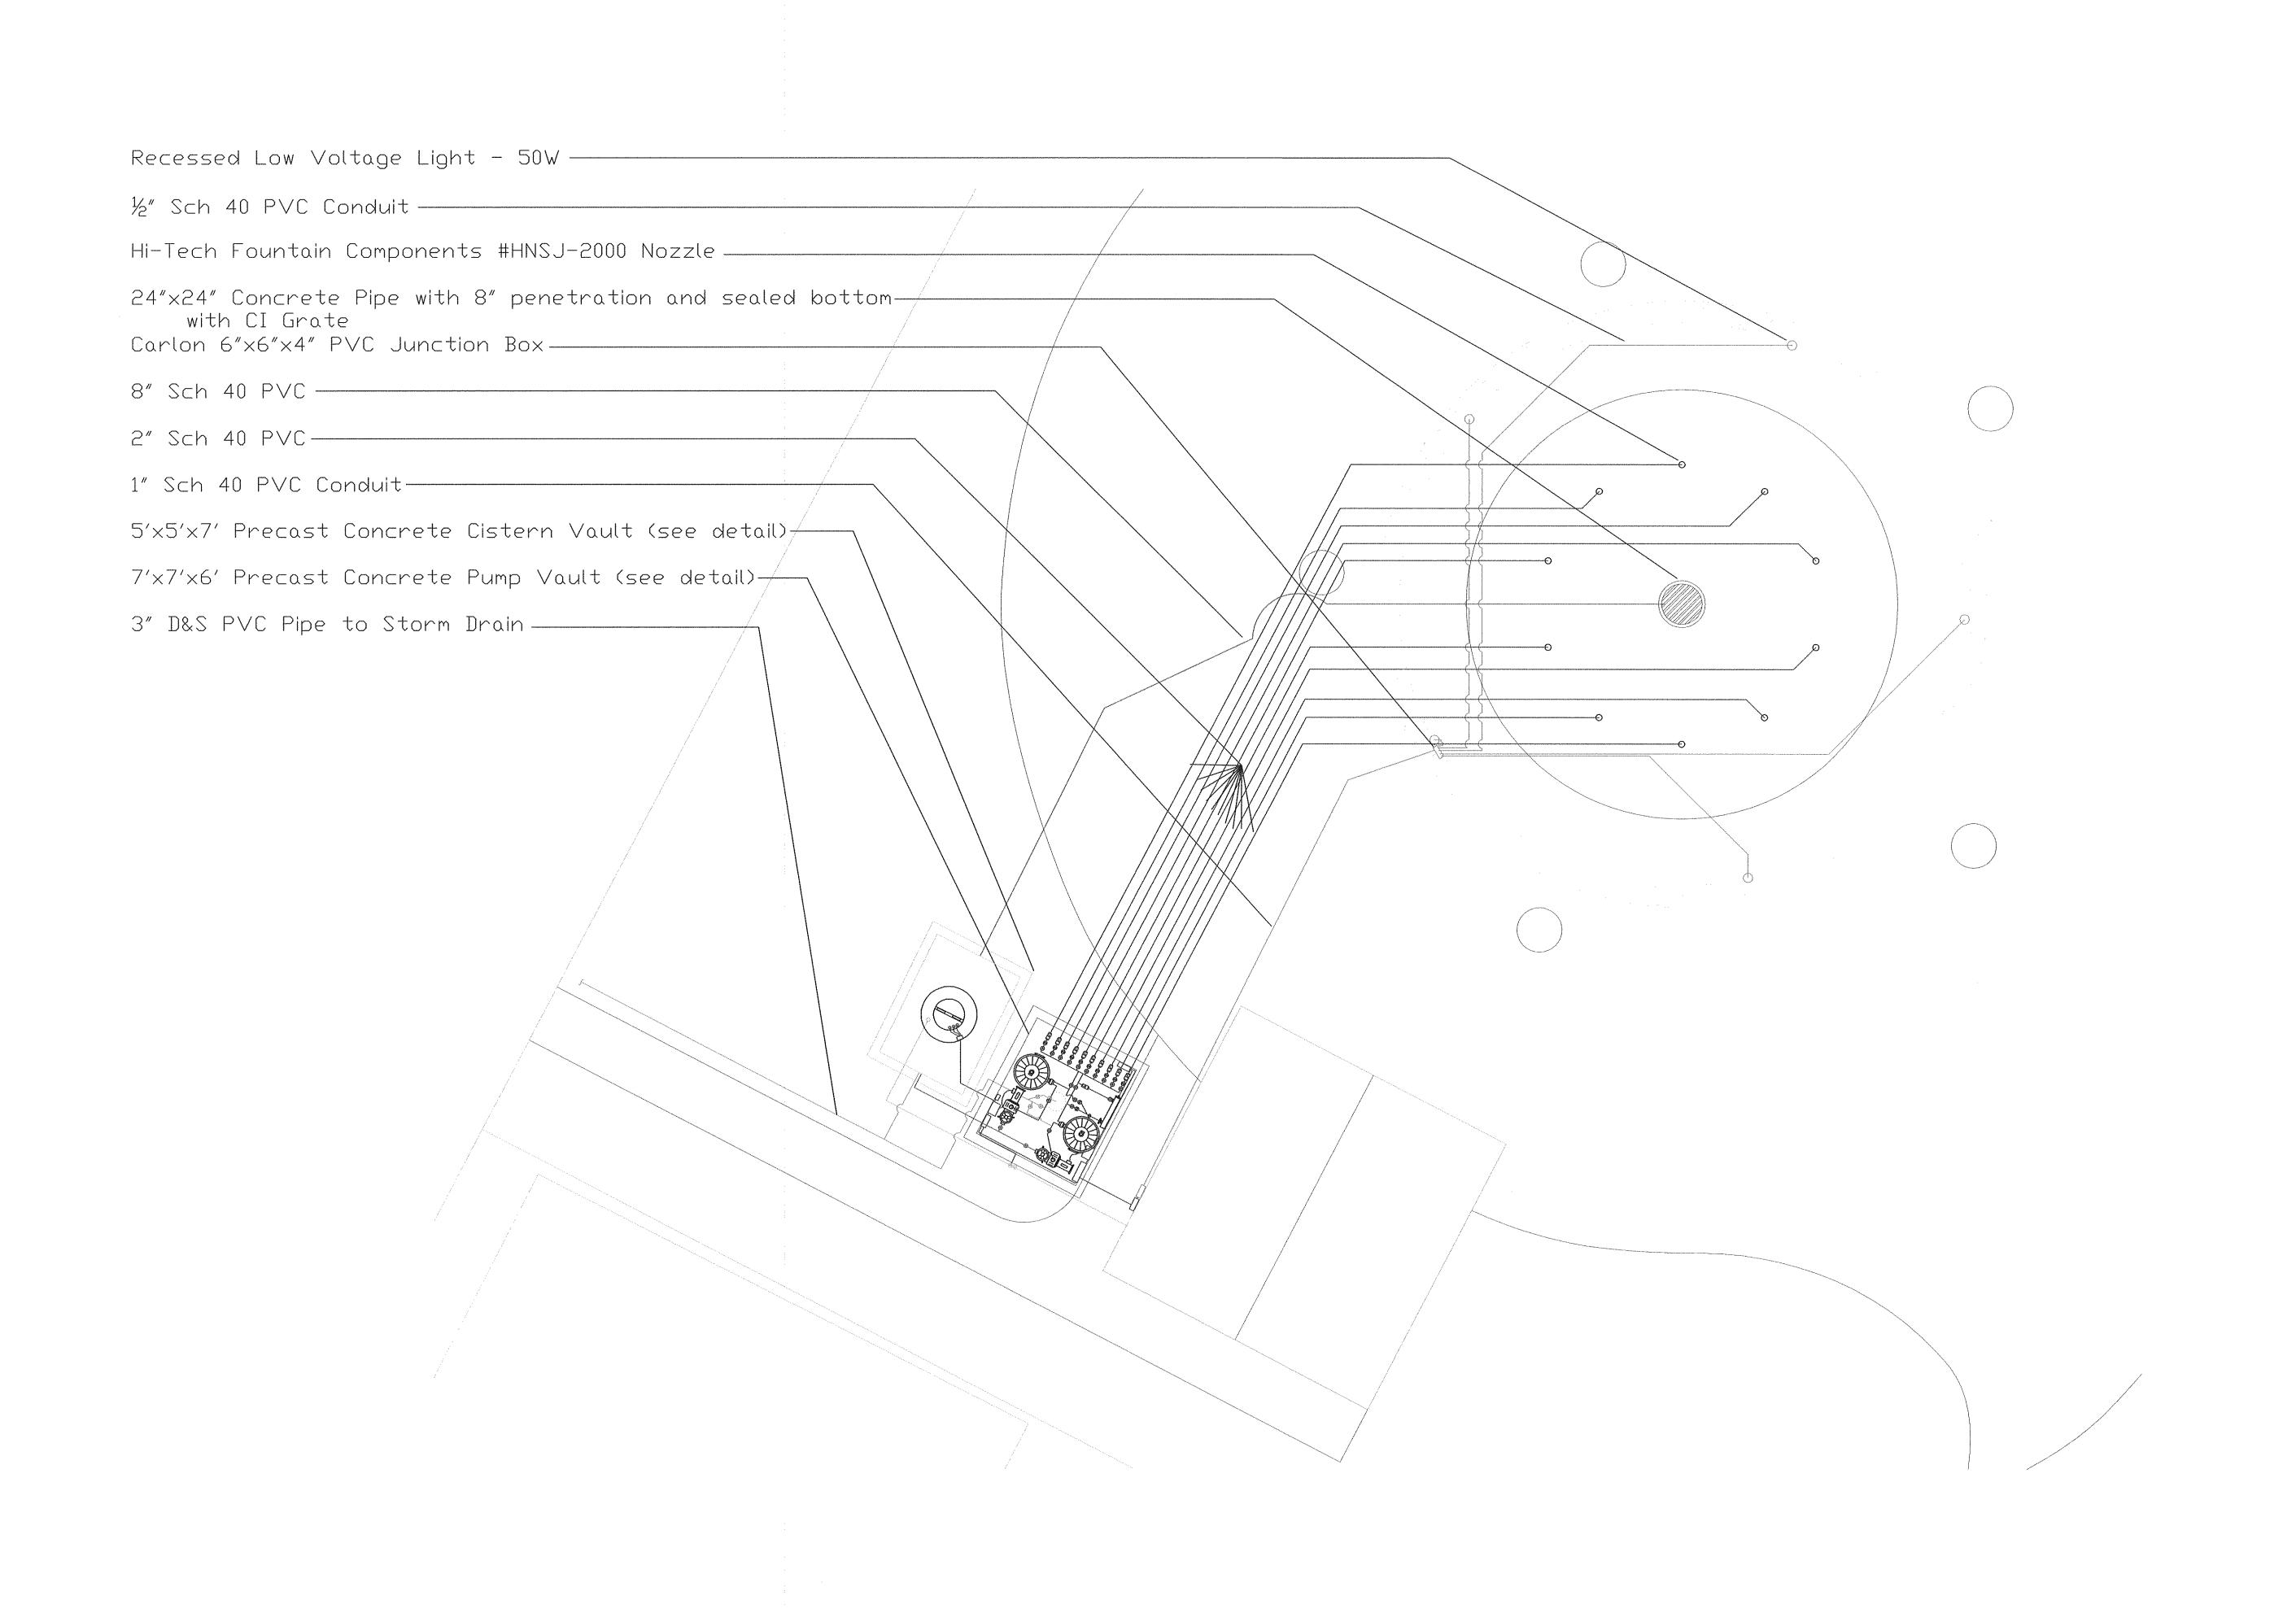







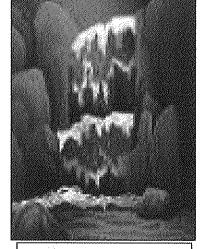

Gresham Design

1941 Lake Whatcom Blvd. #171 Bellingham, WA 98229 (360) 756-0996 Gresham-Design.com

OF FPMAQ(P)
Riverwalk Park-

eet Title:


Fountain Layout


Sheet Number: FL-01

Date: Is

03-07 Prelim Submitta

Design and Drawing:

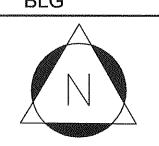


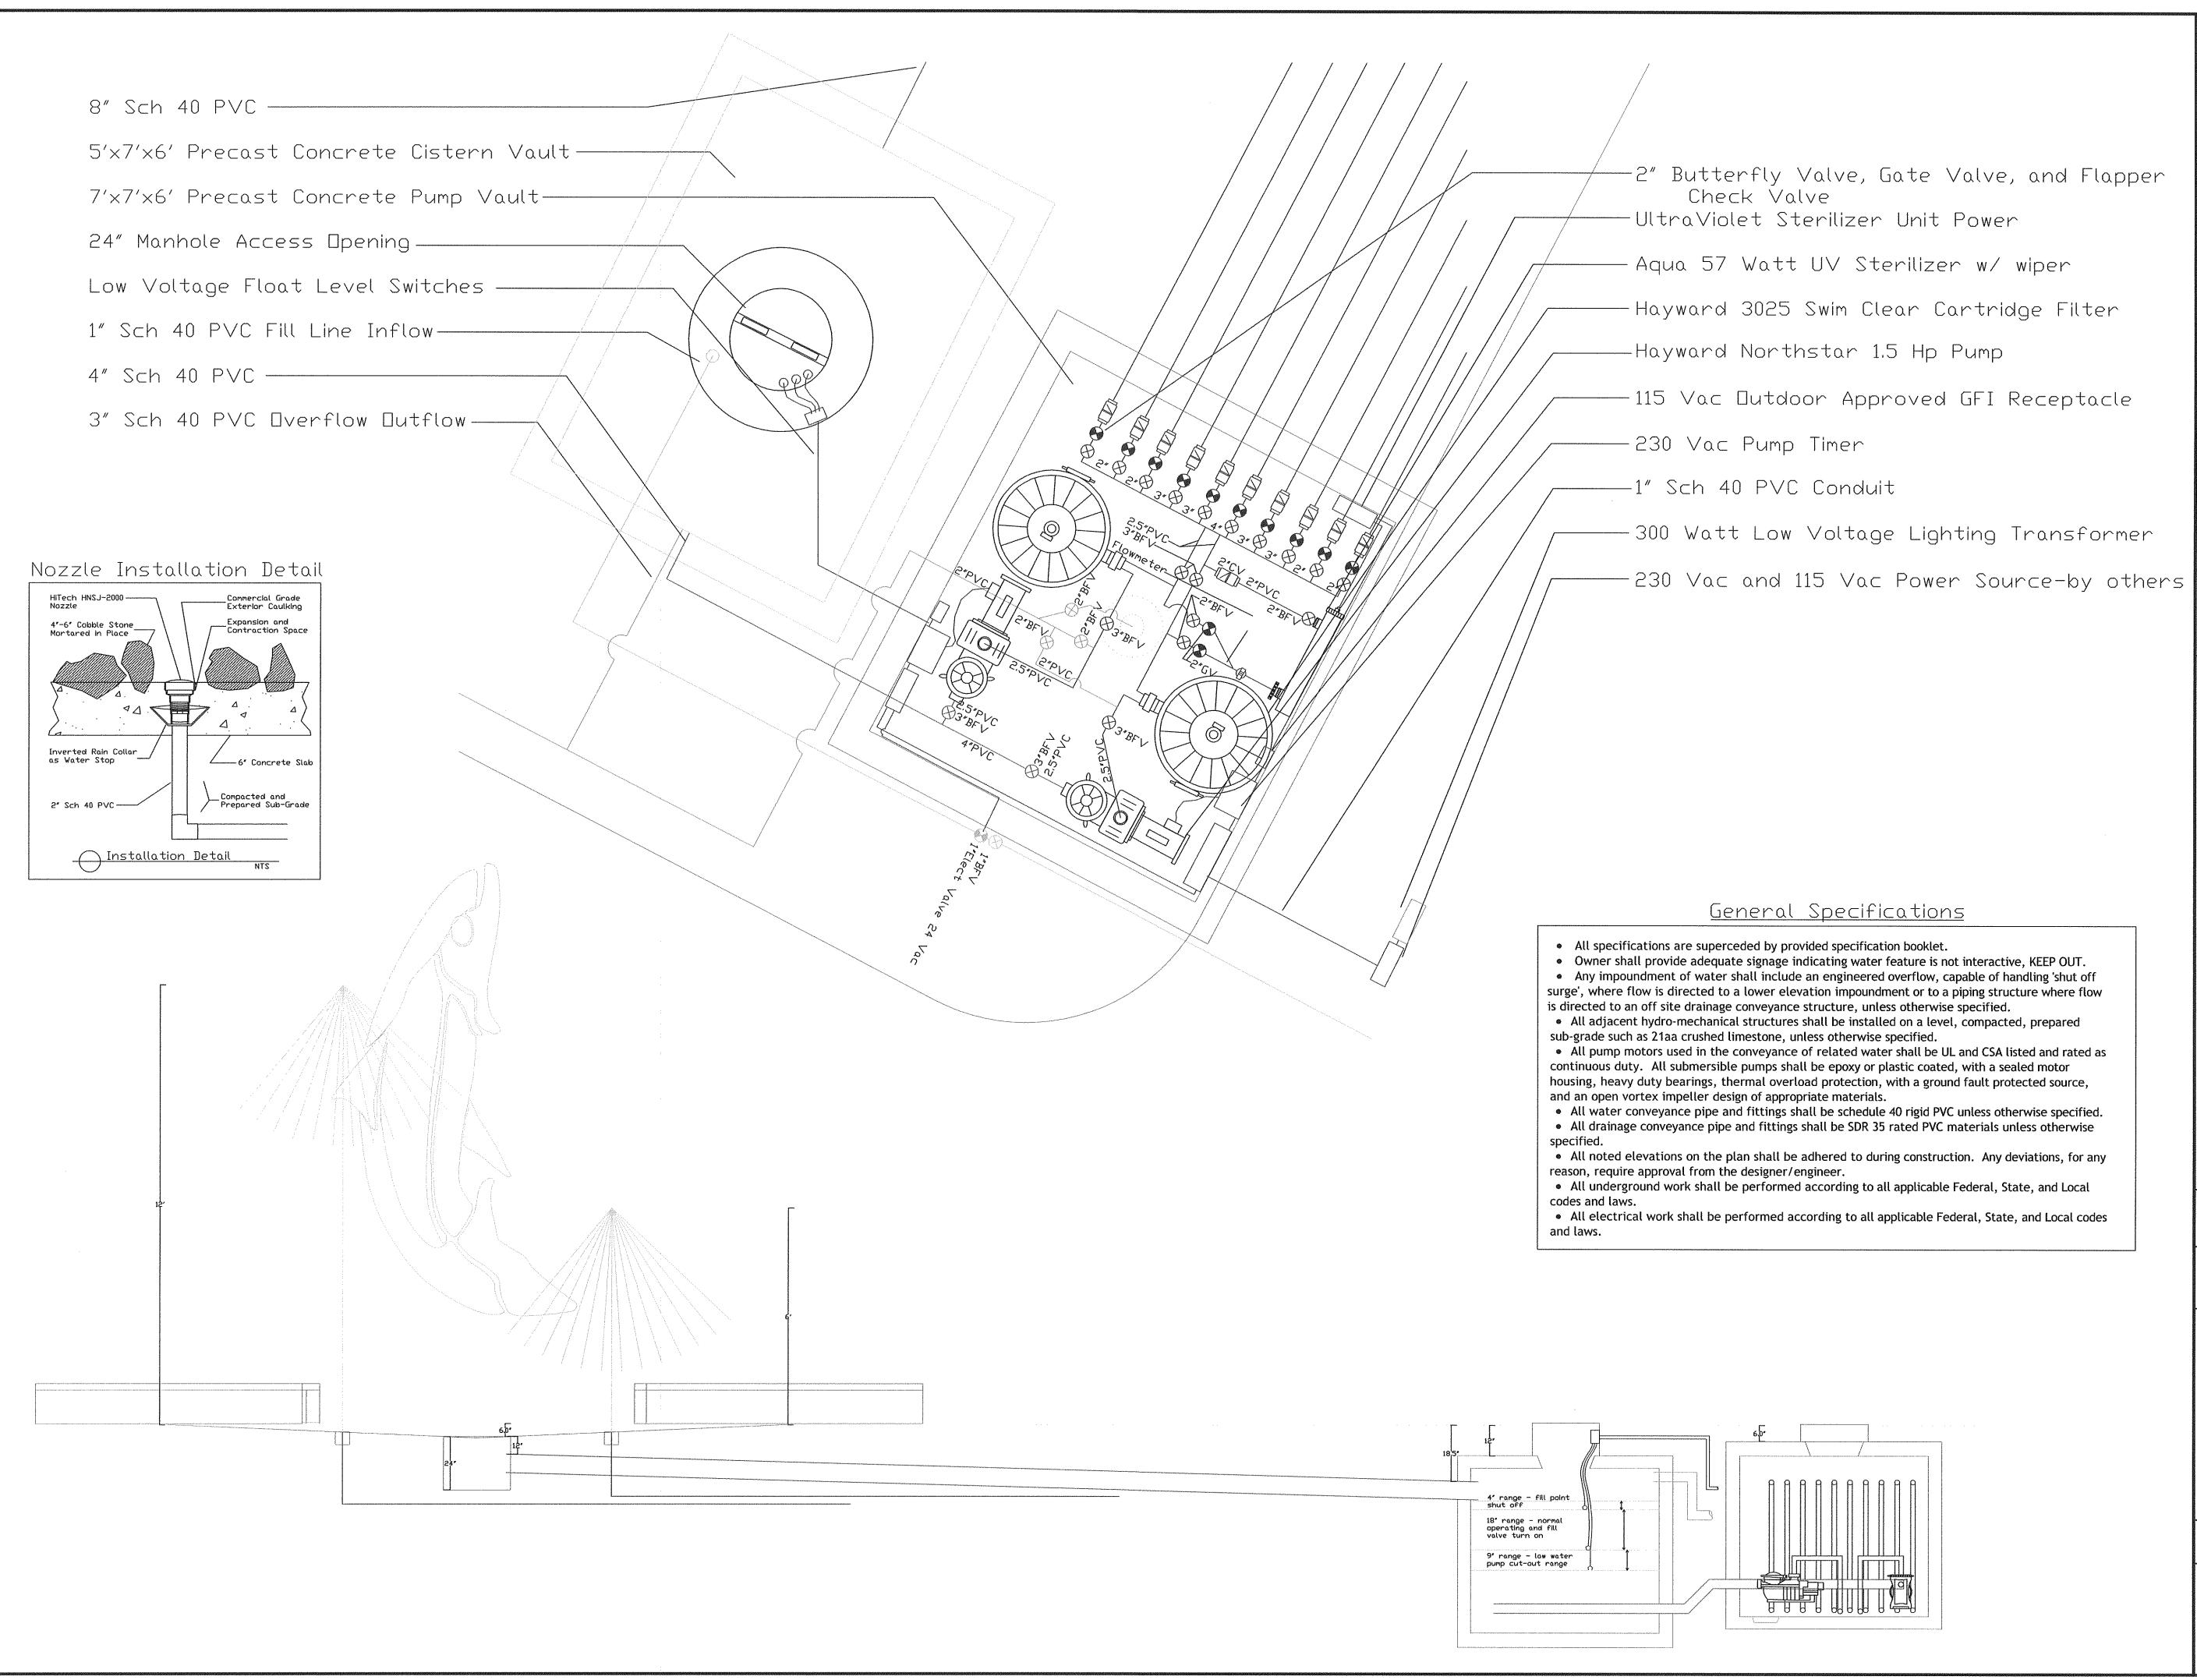







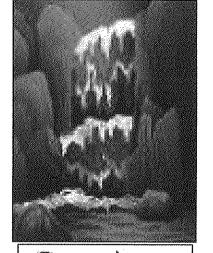

Gresham Design

1941 Lake Whatcom Blvd. #171 Bellingham, WA 98229 (360) 756-0996 Gresham-Design.com

> HTY OF FELLOQLE RIVERWALK PARK-FOUNTAIN DETAIL

\circ		
Sheet	Title:	******


Sheet Title: Fountain Detail


Sheet Number:

FD-01

03-07 Prelim Submitta

Design and Drawing: BLG

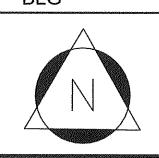


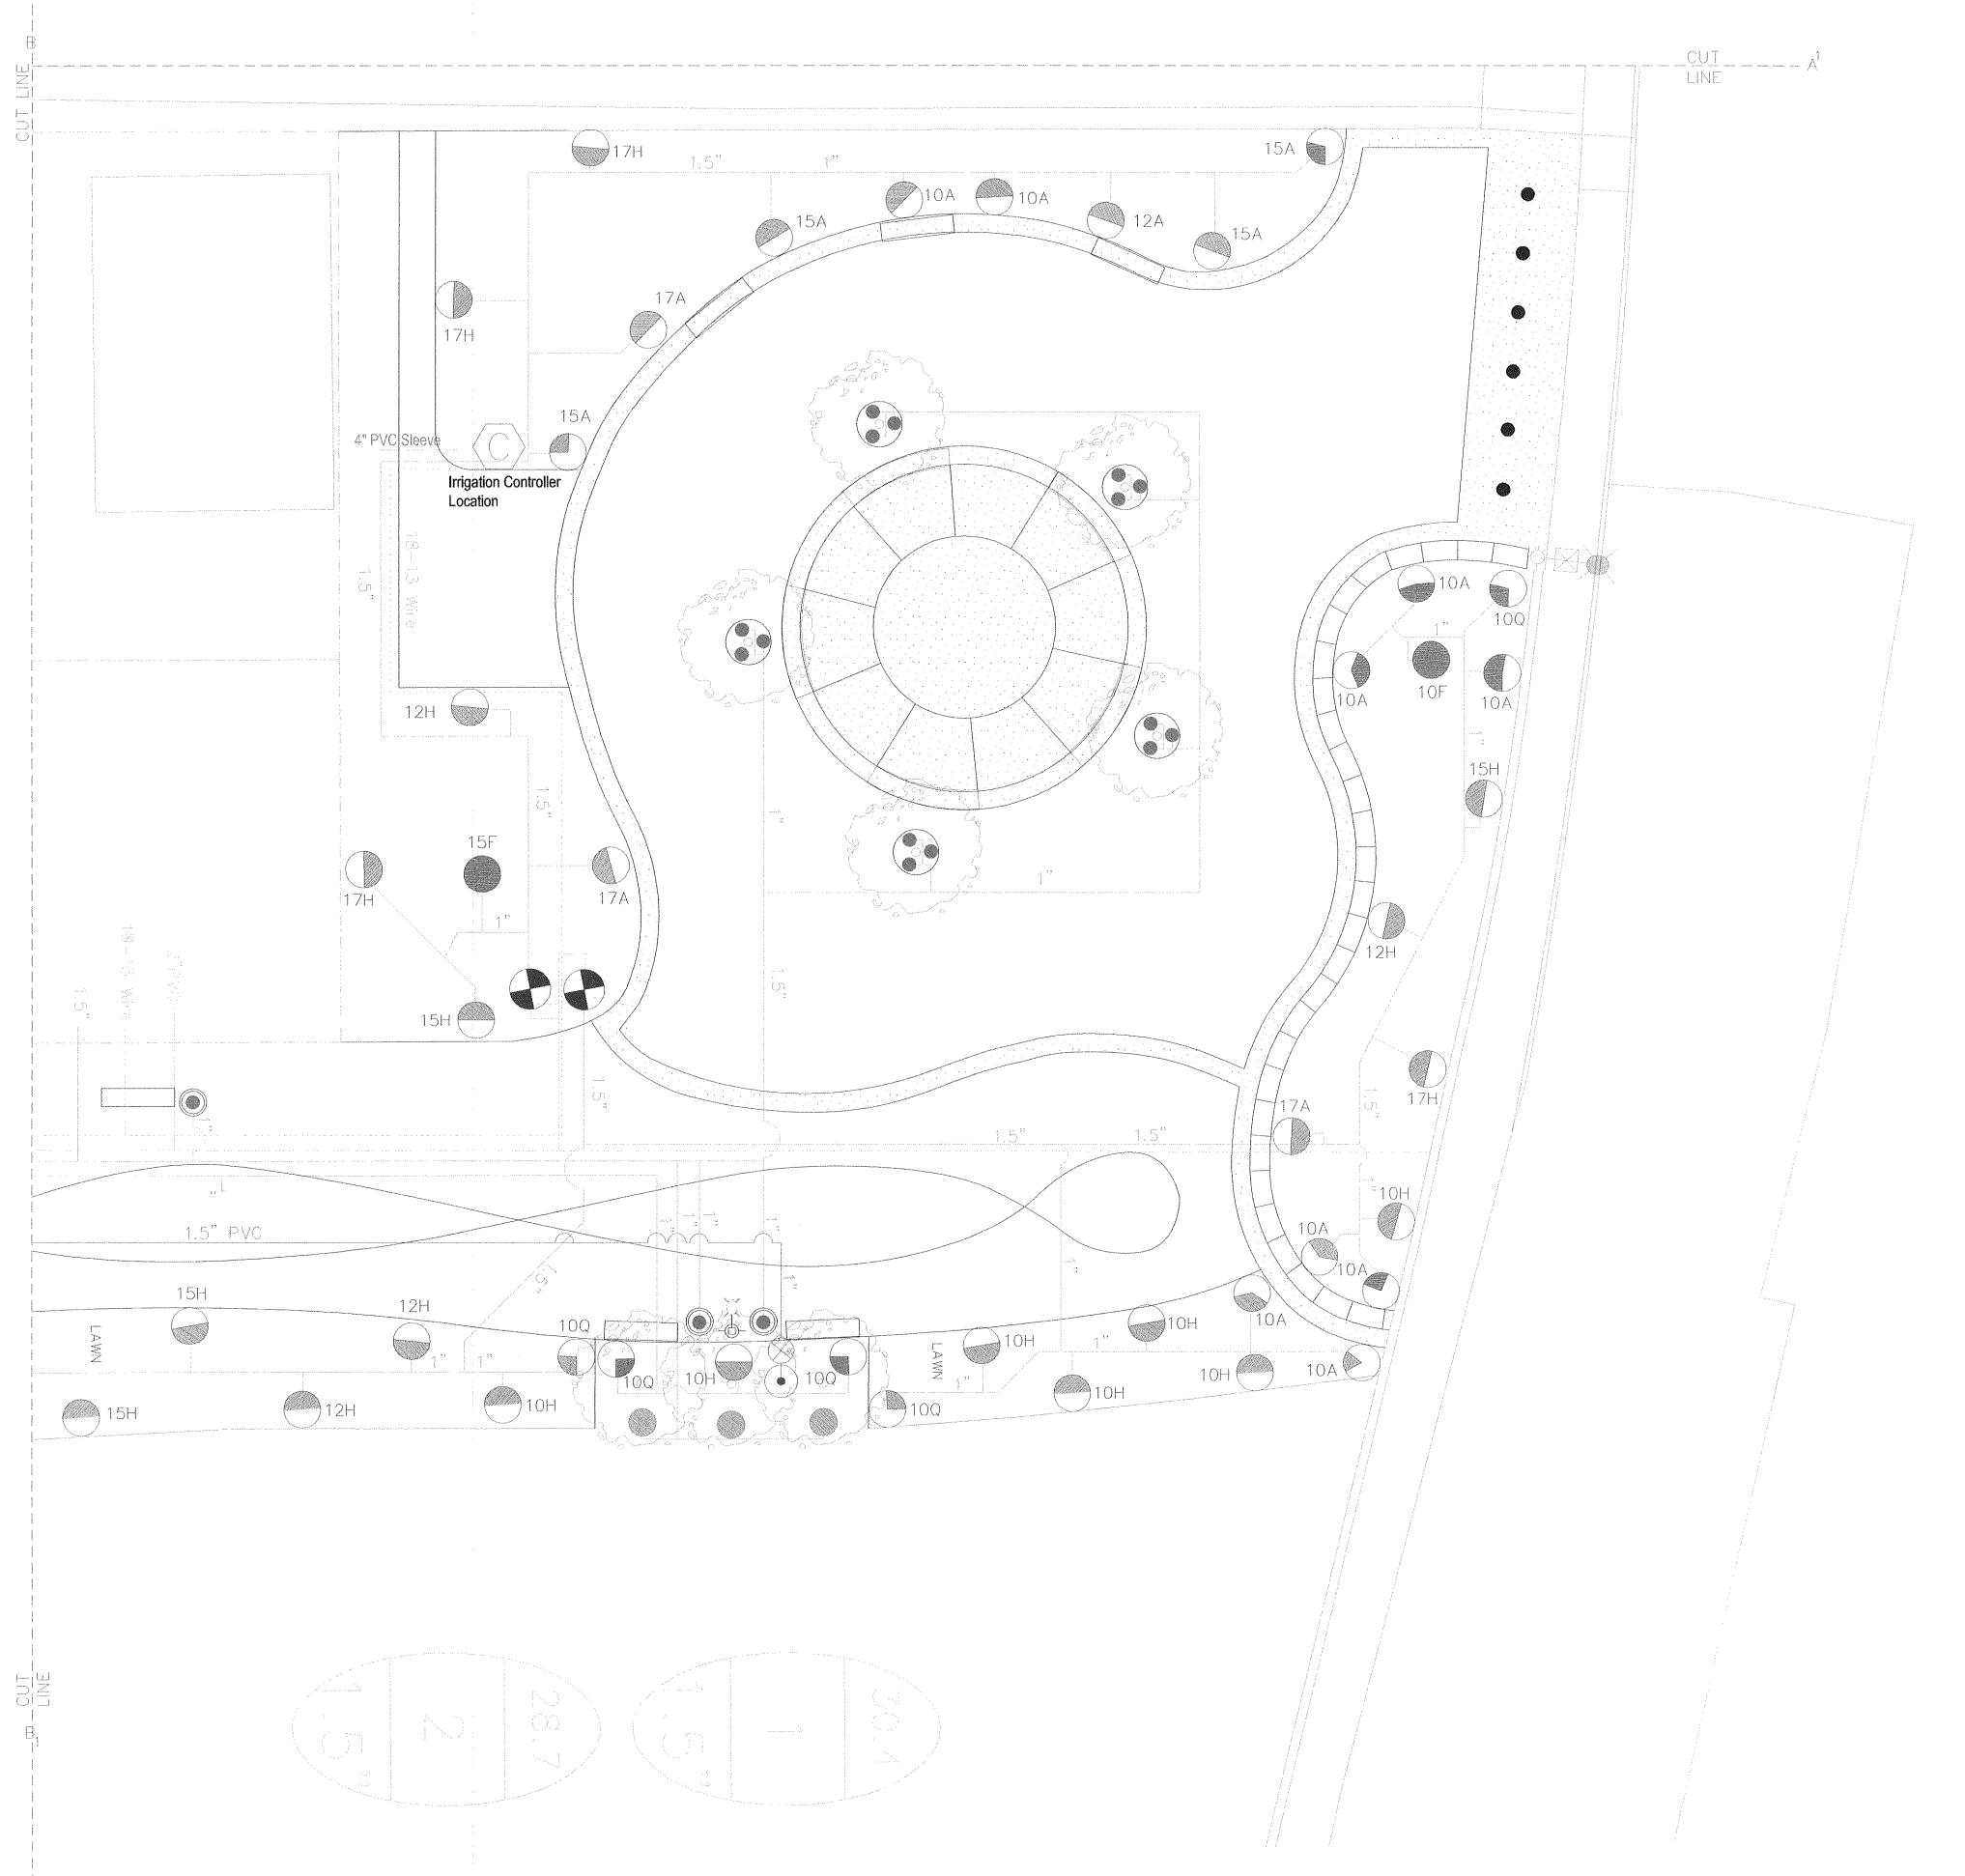







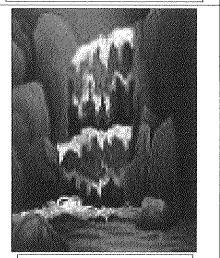

Gresham Design

1941 Lake Whatcom Blvd. #171 Bellingham, WA 98229 (360) 756-0996 Gresham-Design.com

Irrigation Layout


Sheet Number:

03-07 Preliminary Submittal

Design and Drawing: BLG




NOTE: PIPE LAYOUT ON DRAWING IS FOR CLARITY PURPOSES ONLY, ALL PIPE INSTALLED BELOW CONCRETE SHALL BE CONSOLIDATED TO ONE TRENCH, TRENCH DIMENSIONS SHALL NOT EXCEED 24" WIDTH X 36" DEPTH

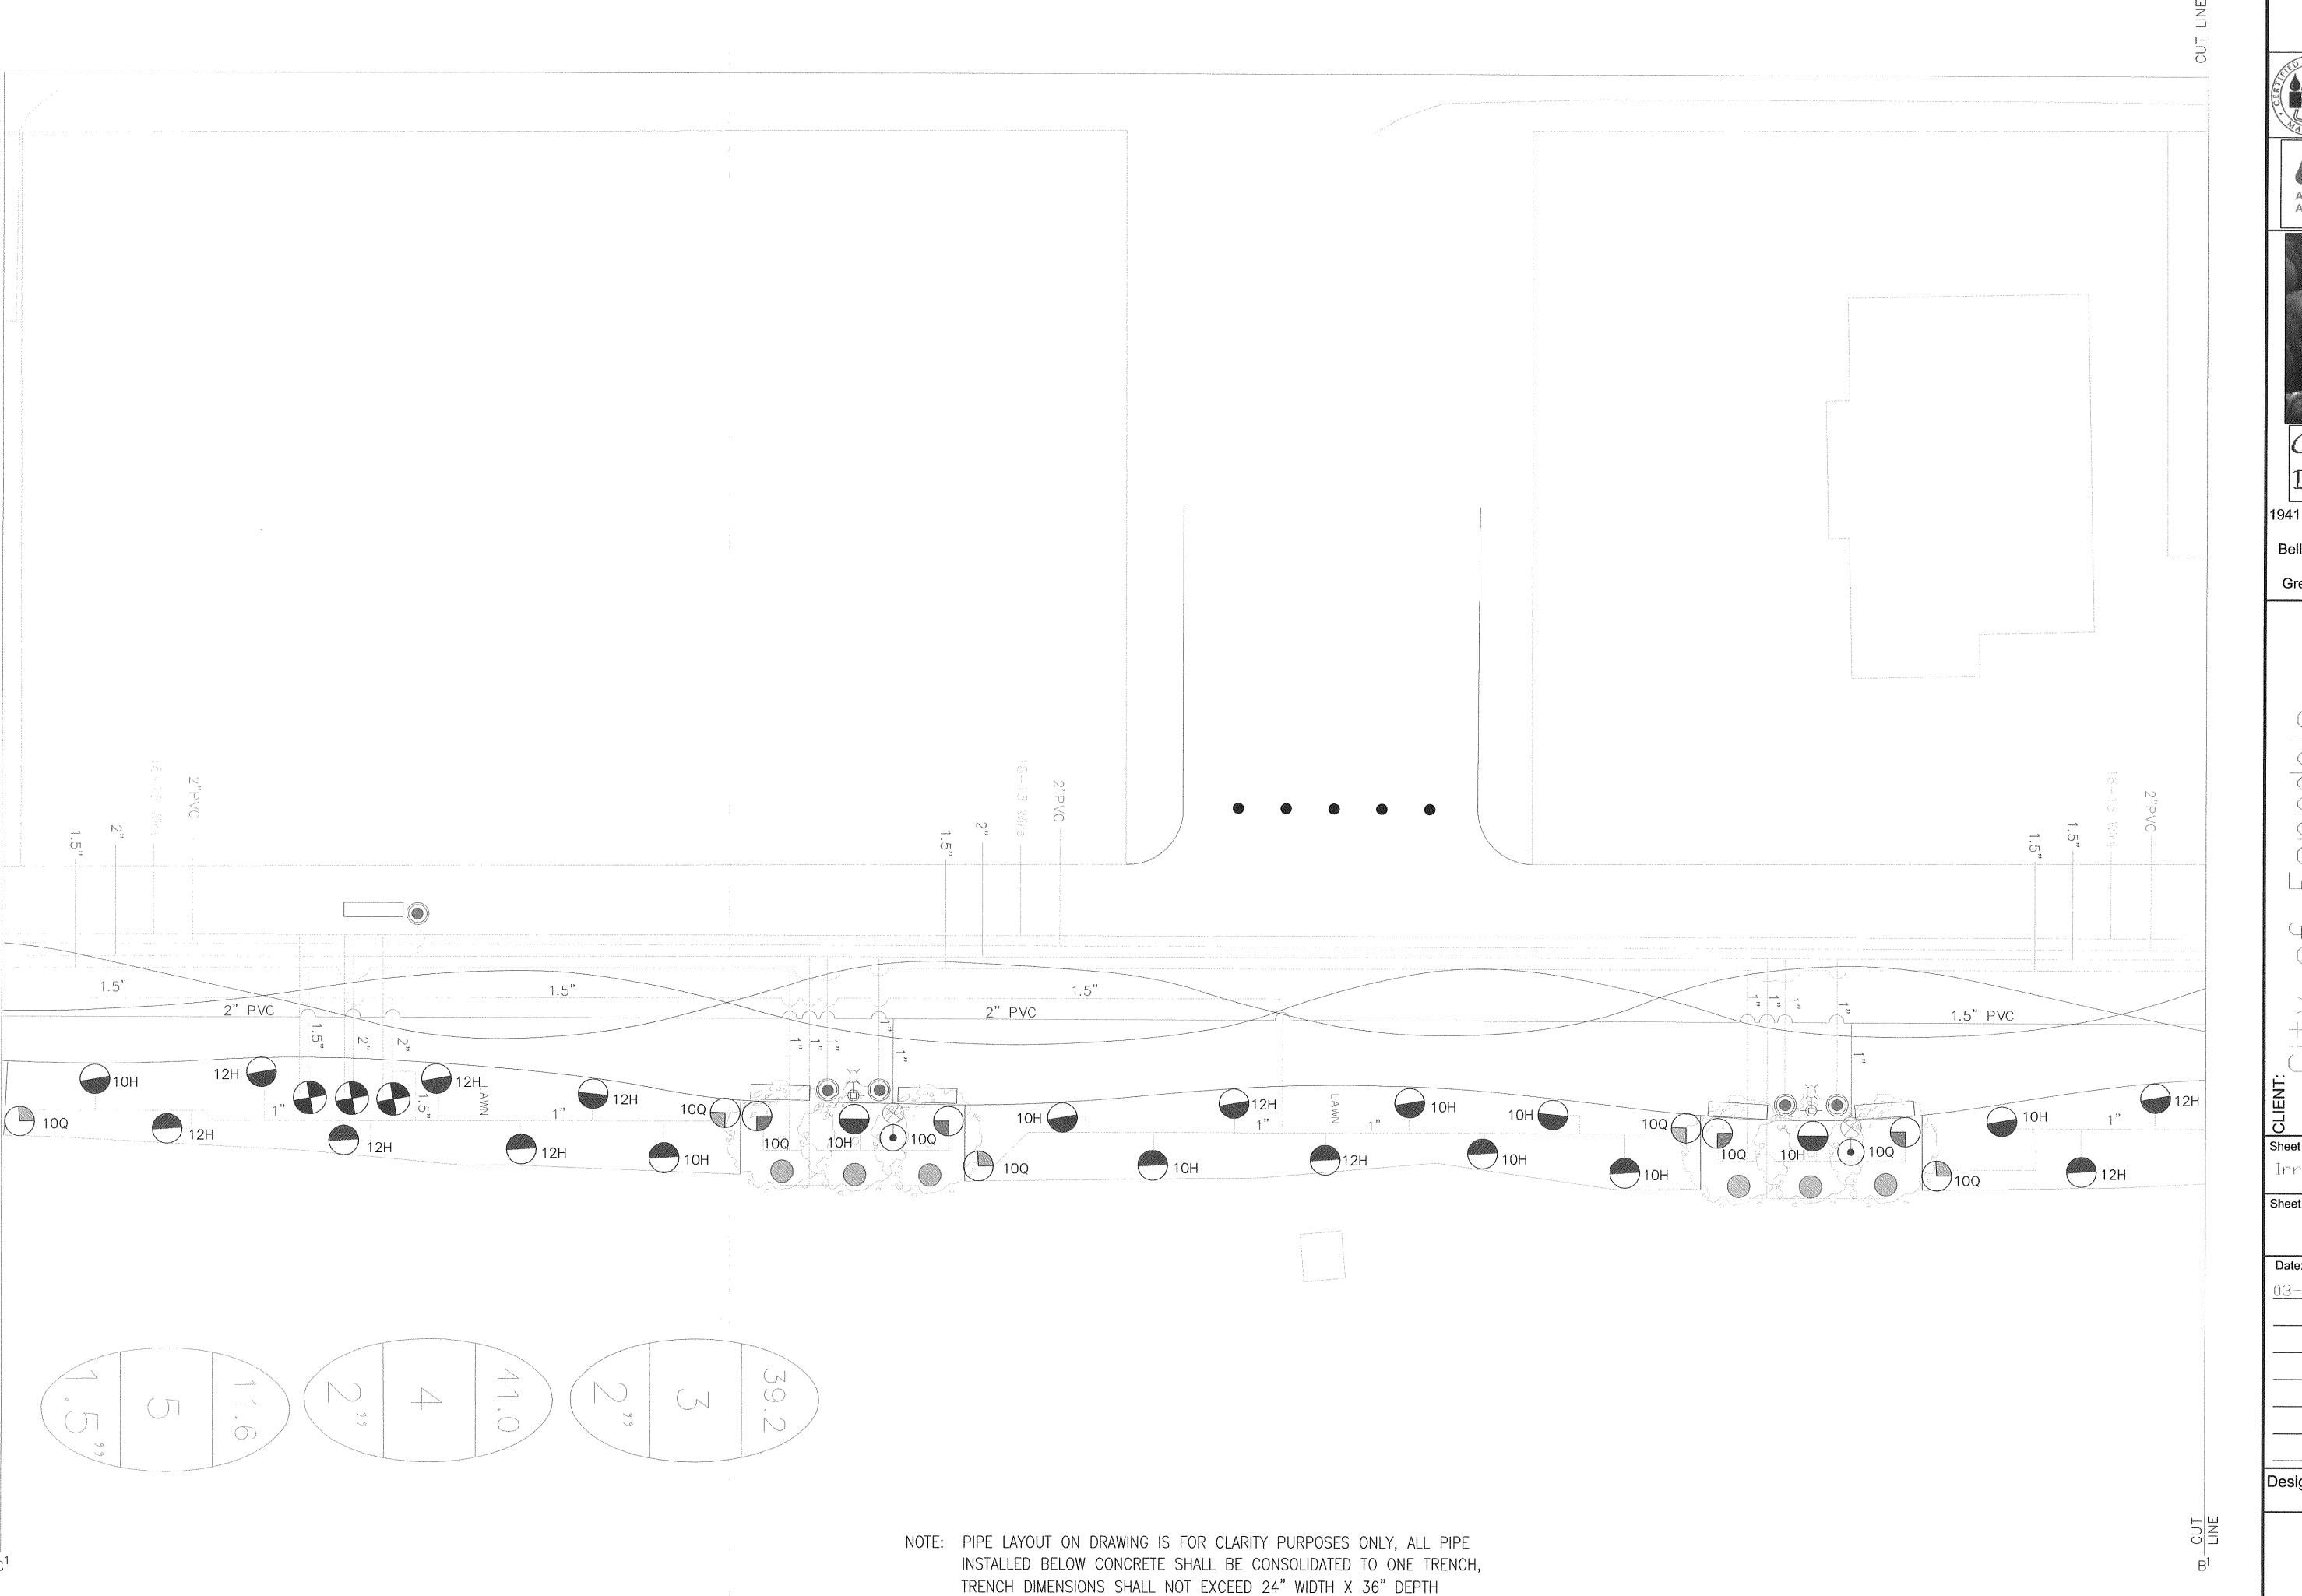







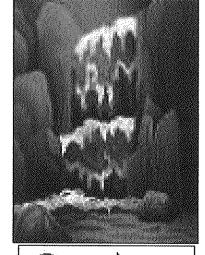

Gresham Design


1941 Lake Whatcom Blvd. Bellingham, WA 98229 (360) 756-0996 Gresham-Design.com

Irrigation Layout


Sheet Number:


03-07 Preliminary Submittal

Design and Drawing: BLG

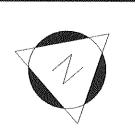



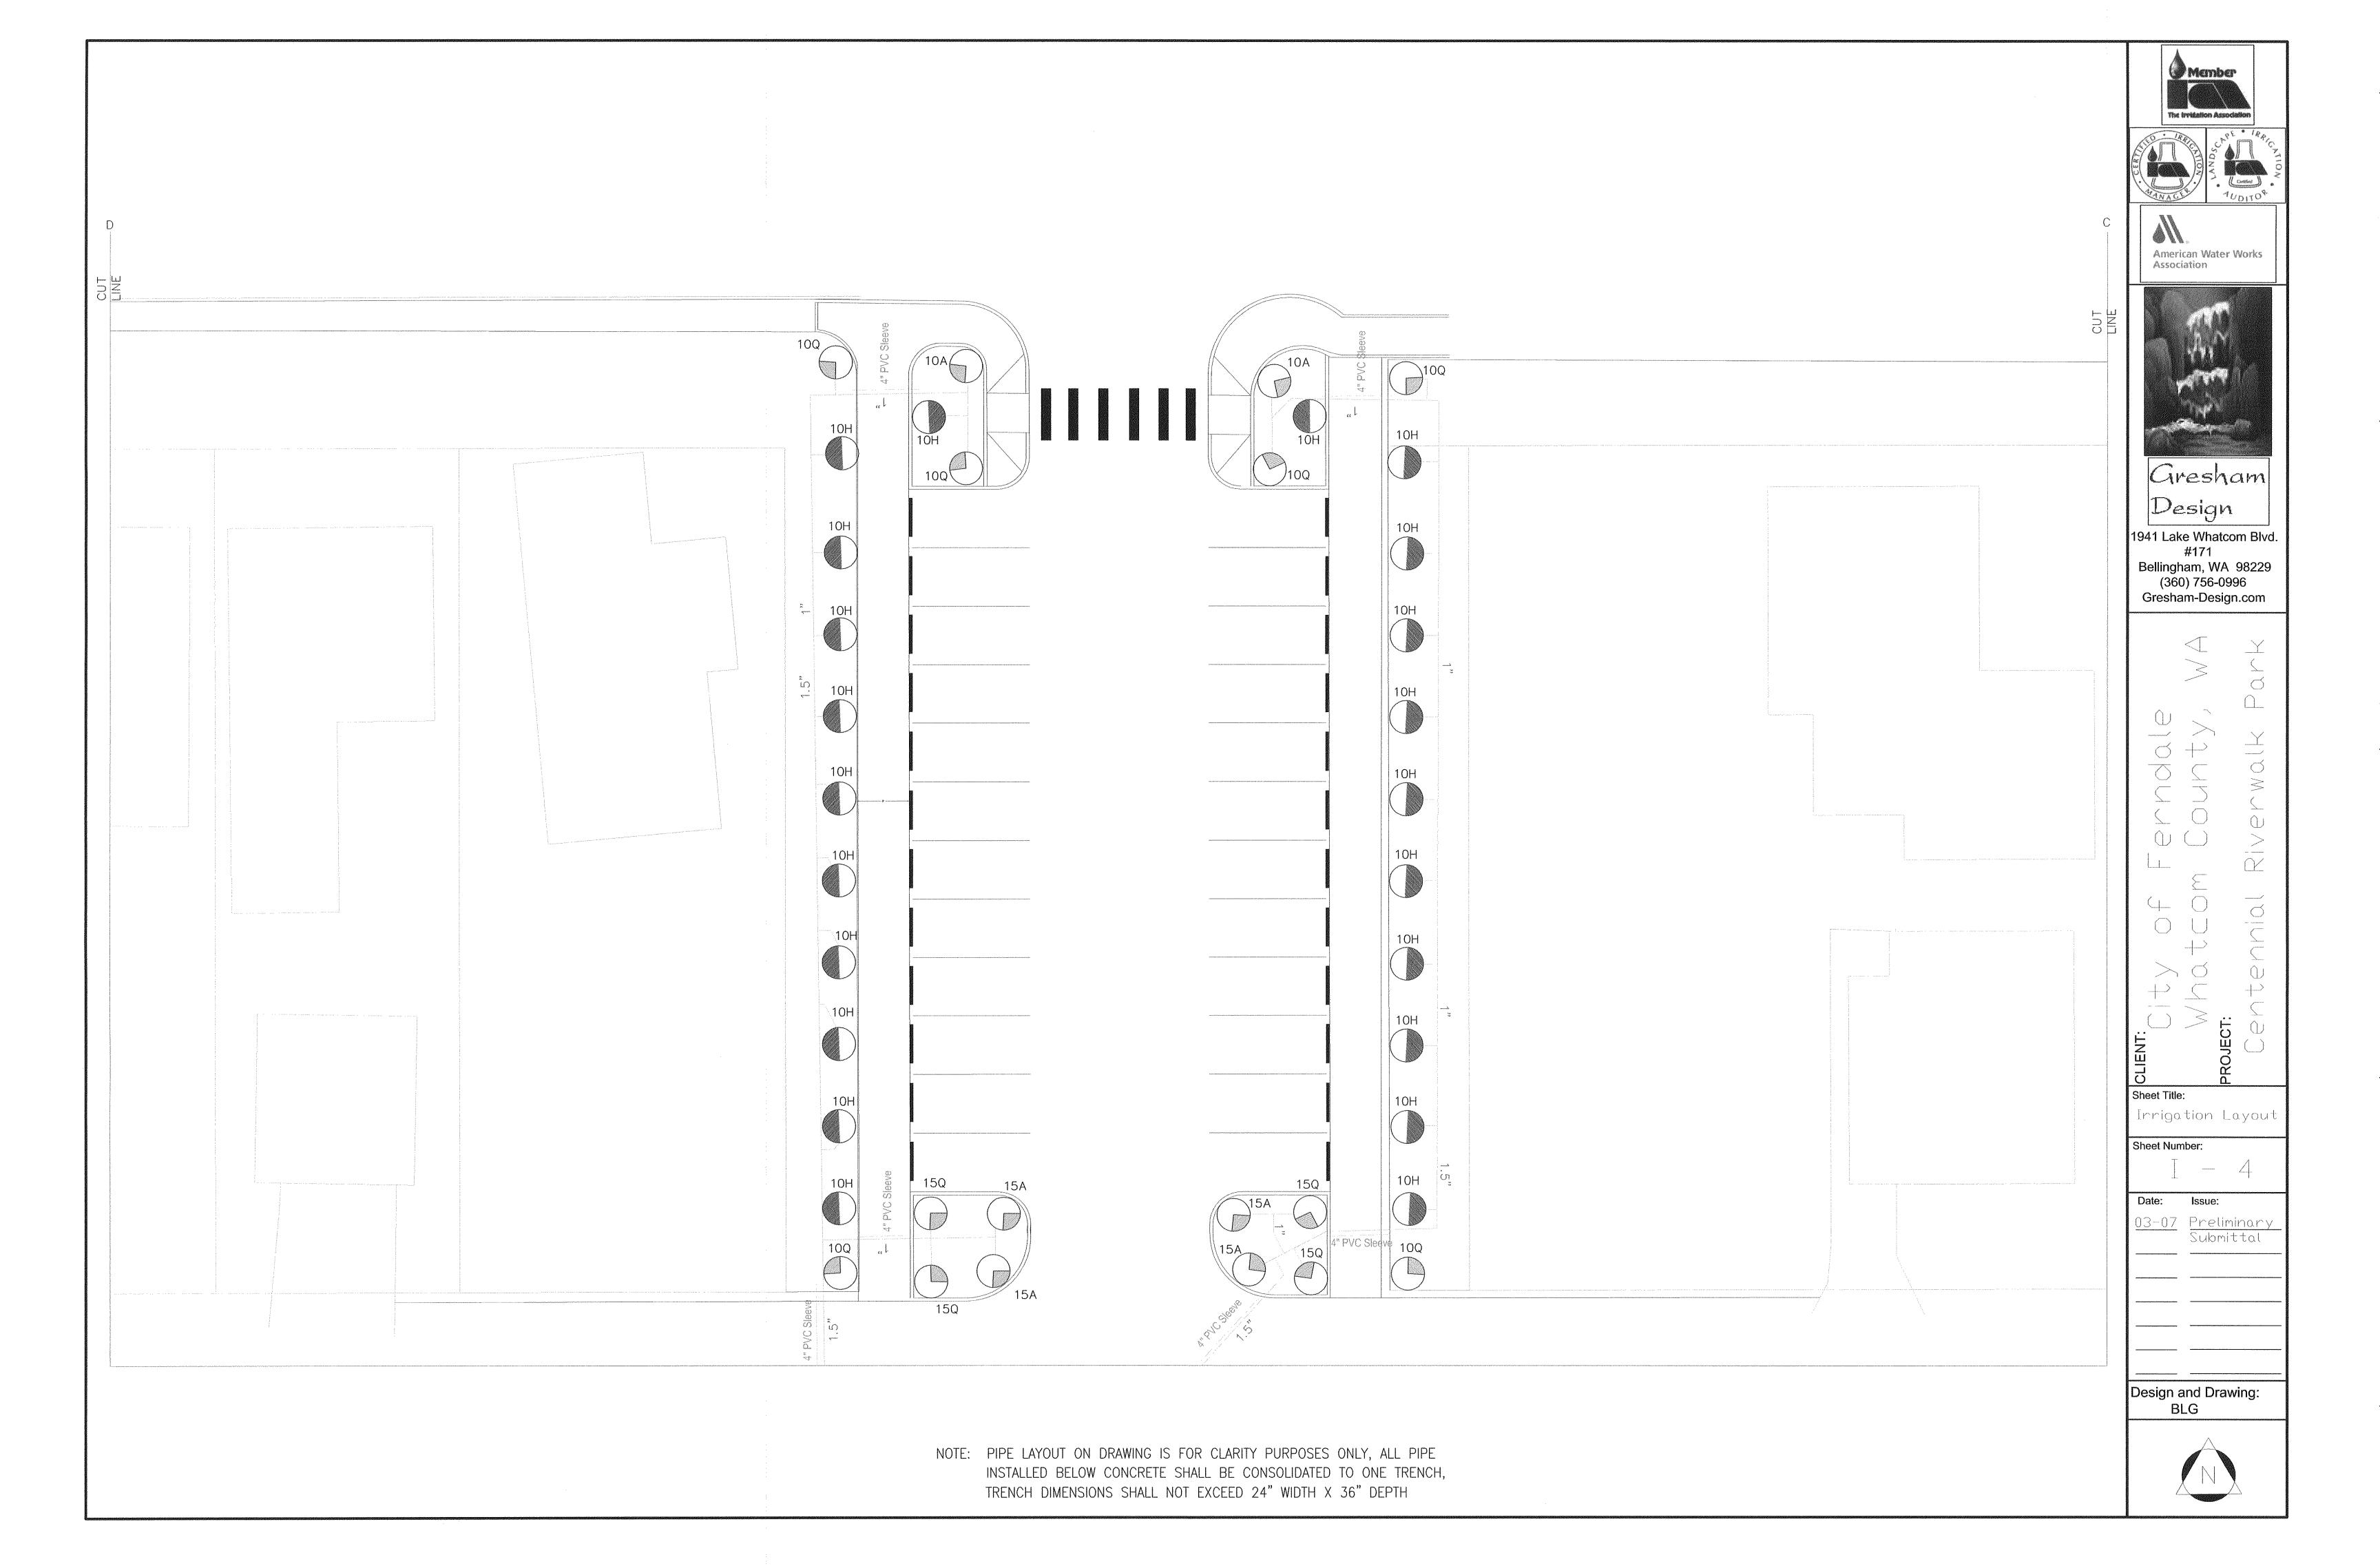


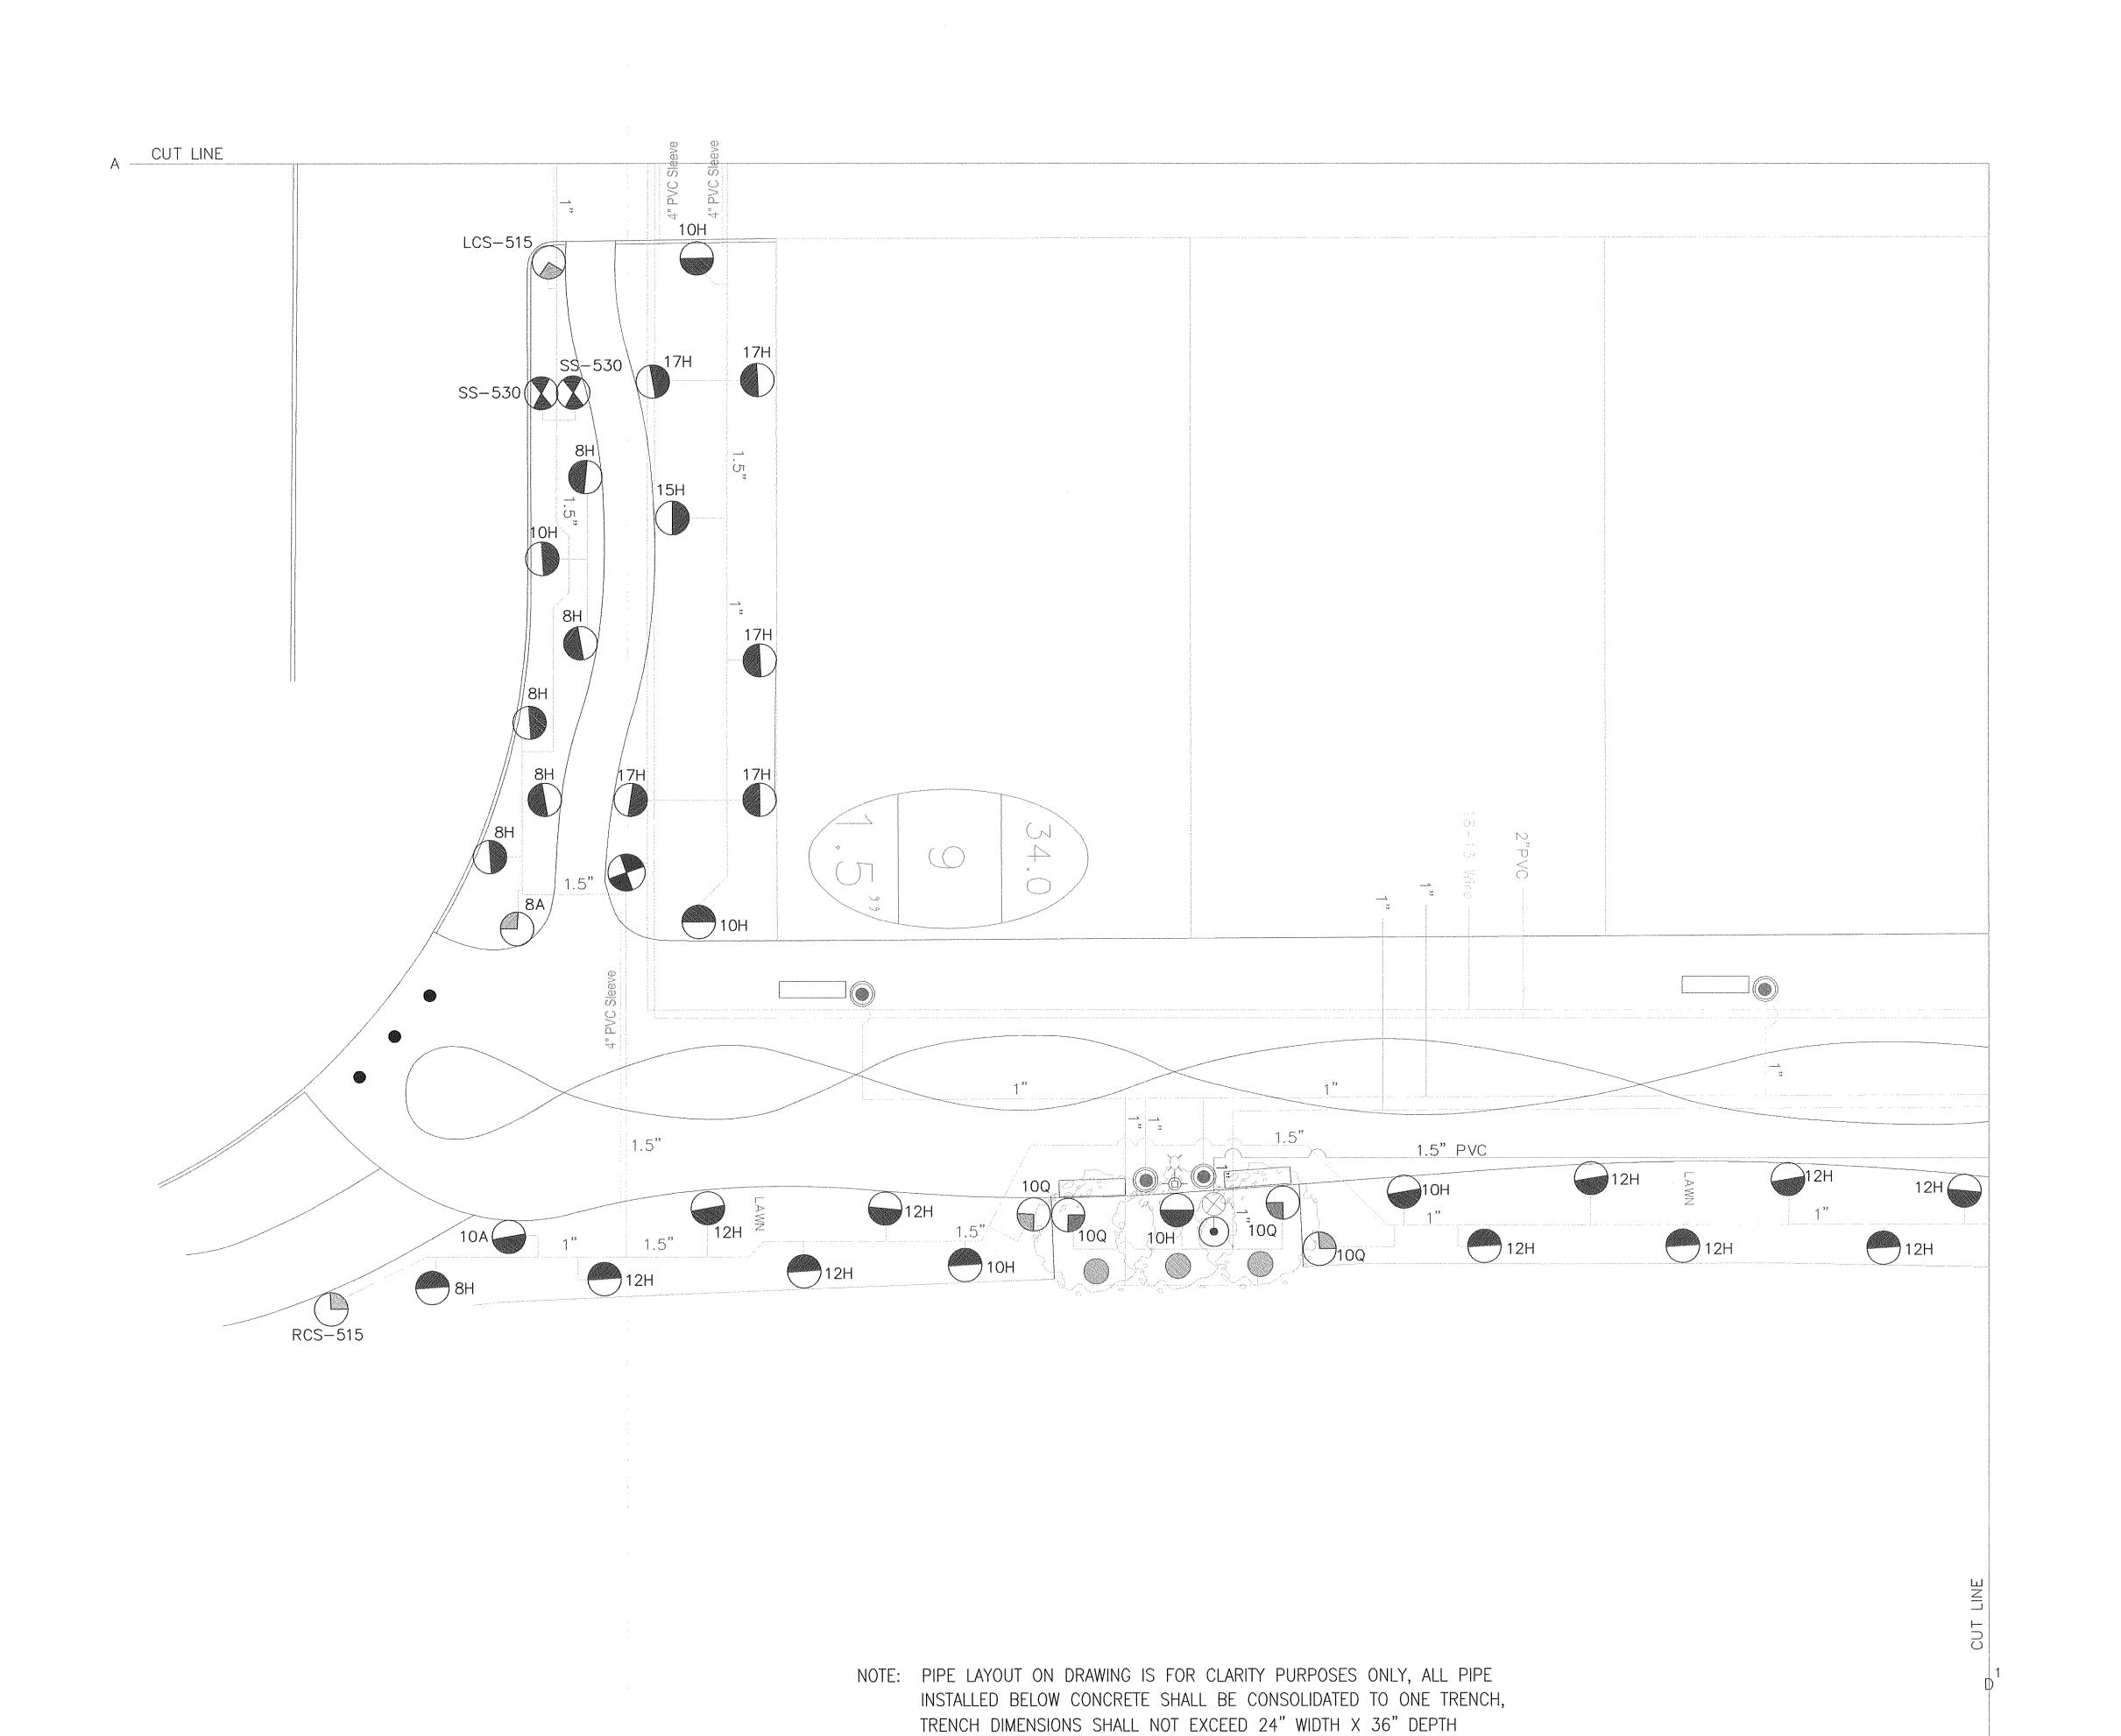







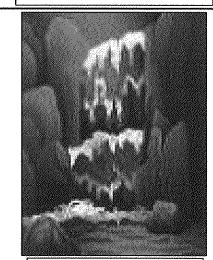

Gresham Design

1941 Lake Whatcom Blvd. #171 Bellingham, WA 98229 (360) 756-0996 Gresham-Design.com

Sheet Title:


Irrigation Layout


Sheet Number:

Date: Issue:

03-07 Preliminary Submittal

Design and Drawing: BLG

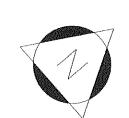


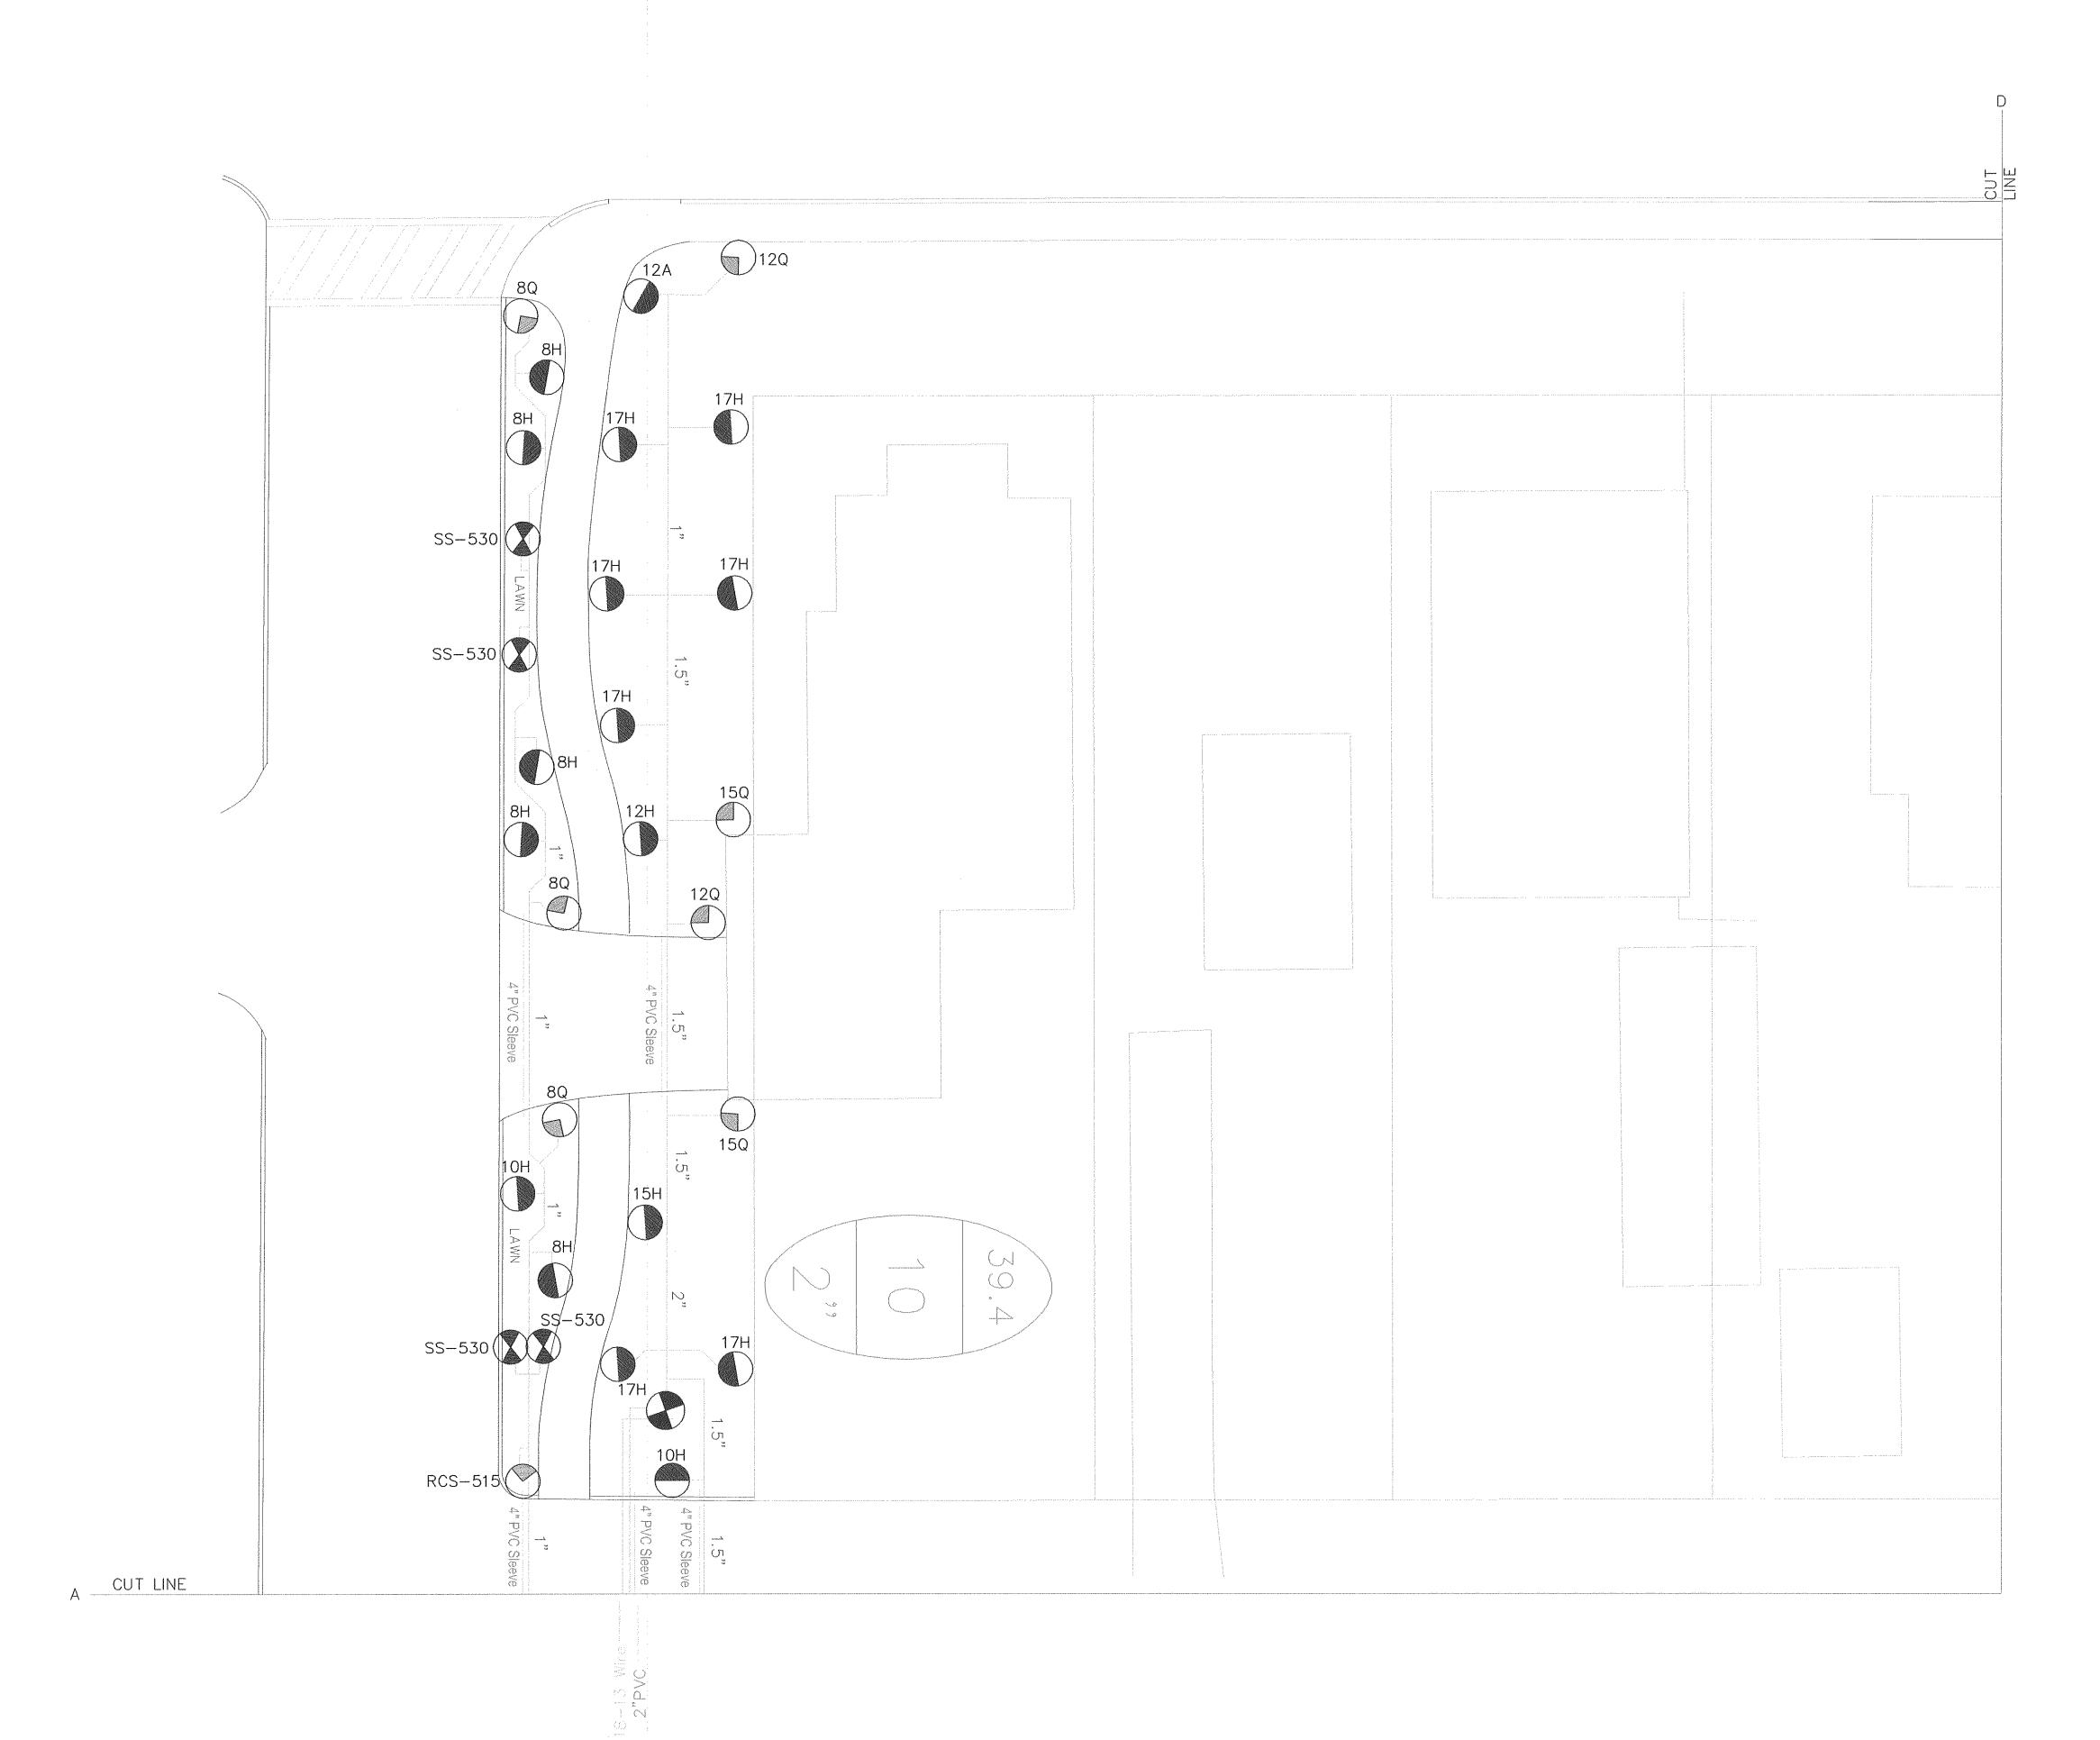







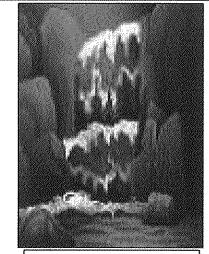

Gresham Design

1941 Lake Whatcom Blvd. #171

Bellingham, WA 98229 (360) 756-0996 Gresham-Design.com

Sheet Title:

Irrigation Layout

Sheet Number:

<u>03-07</u> Preliminary Submittal

Design and Drawing: BLG



NOTE: PIPE LAYOUT ON DRAWING IS FOR CLARITY PURPOSES ONLY, ALL PIPE INSTALLED BELOW CONCRETE SHALL BE CONSOLIDATED TO ONE TRENCH, TRENCH DIMENSIONS SHALL NOT EXCEED 24" WIDTH X 36" DEPTH

IRRIGATION SYSTEM DESIGN CRITERIA

WATER MUST BE DELIVERED TO THE SITE AT SUFFICIENT PRESSURE AND FLOW TO PROVIDE MAXIMUM PERFORMANCE

- 65 PSI WORKING PRESSURE AT FIELD LOCATION AND ELEVATION - 50 PSI AT BASE OF SPRINKLER HEAD

- 7.8 GPM MAXIMUM FLOW RATE - .50 GPM MINIMUM FLOW RATE

DIFFERENCES IN AVAILABLE FLOW AND OR PRESSURE WILL REQUIRE DESIGN CHANGES.

WATER SERVICE LINE, WATER METER, BACKFLOW PREVENTION DEVICE, PRESSURE CONTROLS, CHECK VALVES, SURGE PROTECTION, ETC., AND PERFORMANCE OF THE WATER SOURCE ARE NOT A PART OF THESE DRAWINGS.

HEAD LAY-OUT AND SPACING IS VARIABLE AND BASED ON ADJACENT HARDSCAPE DIMENSIONS. IN GENERAL, CHECK ADJACENT HEAD DISTANCE FOR DETERMINATION.

HEAD AND LATERAL SPACING WILL VARY WITH DIMENSIONS OF FIELD. ADJUSTED SPACINGS WILL BE NECESSARY ON ASYMMETRICAL FIELDS OR FIELDS WITH DEEP CENTERS. ALL SPRINKLERS AND NOZZLES SHOULD BE SELECTED BASED ON SPRINKLER PERFORMANCE, SPACING, AND ARC OF COVERAGE, AND ACCORDING TO FIELD DIMENSIONS.

SEE APPROPRIATE SPECIFICATION DOCUMENT FOR PERFORMANCE STATISTICS. THEY WERE CALCULATED BASED ON INFORMATION SHOWN ON THIS PLAN. CHANGES IN OPERATING PRESSURE, HEAD SPACING AND OR NOZZLE SIZE WILL EFFECT RESULTS.

IRRIGATION LEGEND

DESCRIPTION

GPM RADIUS ARC

50 SEE IRRIGATION HEAD LEGEND

RAINBIRD 1800 SERIES SPRAY HEAD

30 SEE IRRIGATION HEAD LEGEND

30 SEE IRRIGATION HEAD LEGEND

RAINBIRD 1800 SERIES SPRAY HEAD

• WEATHERMATIC 21000CR SERIES REMOTE CONTROL VALVE AS SIZED IN CALLOUT

• WOOLFORD 3/4" FREEZELESS YARD HYDRANT VALVE # Y95

WATTS 2" NPT GATE VALVE FOR MAINLINE ISOLATION OR EQUIV

WATTS 1" NPT GATE VALVE FOR PRESSURIZED ISOLATION OR EQUIV

BACKFLOW PREVENTION DEVICE - (NOT SHOWN) PER WHATCOM COUNTY (AS REQUIRED PER CODE AND/OR ORDINANCE - AND FOR SAFETY)

18-13 UL LISTED SPRINKLER WIRE 600 VOLT SOL BC DIRECT BURIAL

NON-PRESSURE PIPE (PVC CLASS 160 RECOMMENDED)

PRESSURE PIPE (PVC CLASS 200 RECOMMENDED)


POTABLE WATER LINE PRESSURE PIPE (PVC CLASS 200 RECOMMENDED)


SLEEVING PIPE (PVC SDR 35 RECOMMENDED)


RAINBIRD ESP-MC12 12 STATION CONTROLLER


/39.4 VALVE FLOW IN GPM - VALVE SEQUENCE NUMBER


2"—VALVE SIZE — NPT

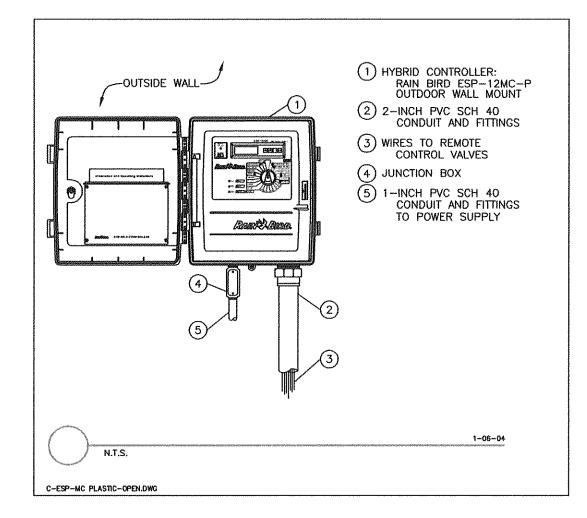


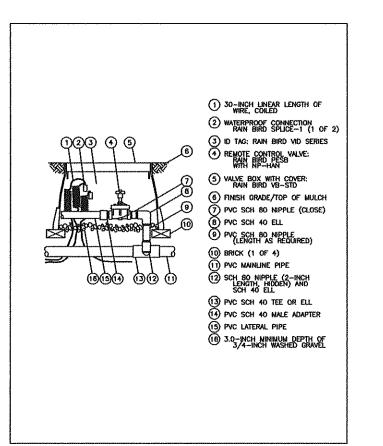

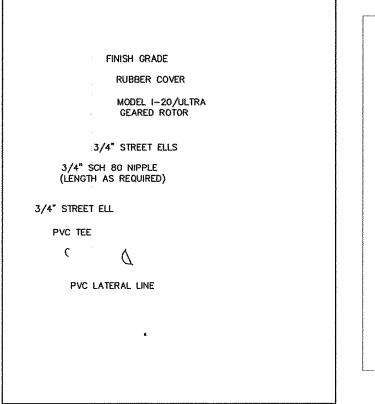


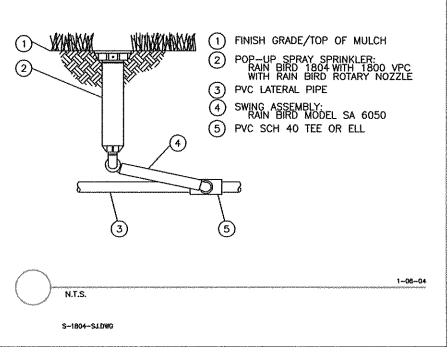

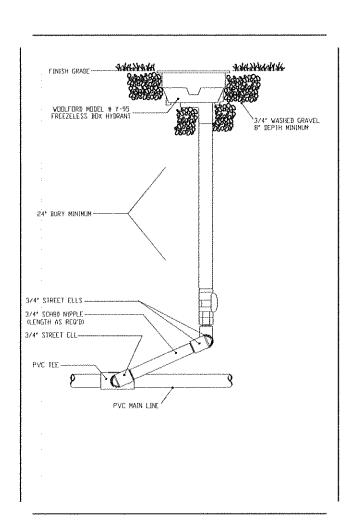

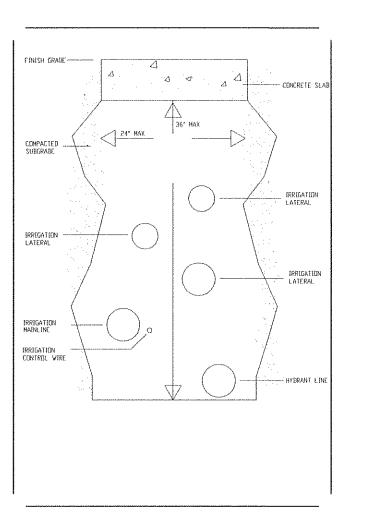


SYMBOL		·							DIS	SCHAR(GE (GP	M)											
360"	ADJ 270*	ADJ 240*	180	ADJ 120*	90,	ADJ 45	LCS	RCS	SS	DESCRIPTION	MANUFACTURER / MODEL	PSI	RAD.	360'	ADJ 270'	ADJ 240*	180*	ADJ 120*	90.	ADJ 45	LCS	RCS	ss
	9	0	0	0	•	0	0	<u>@</u>	0	POP-UP SPRAY HEAD	HUNTER PROS-06-CV-17	30	16' – 17	4.82	3.61	3.21	2.41	1.61	1.20	0.60			
	0	0	0	0	0	0	0	3	0	POP-UP SPRAY HEAD	HUNTER PROS-06-CV-15	30	13' - 15	3.71	2.79	2.48	1.86	1.24	0.93	0.46			
	9	9	0	0	0	0	0	9	8	POP-UP SPRAY HEAD	HUNTER PROS-06-CV-12	30	11' - 12	2.85	2.14	1.90	1.42	0.95	0.71	0.36			
	•	0	0	(•	0	0	(3)	8	POP-UP SPRAY HEAD	HUNTER PROS-06-CV-10	30	7' - 10'	1.95	1.46	1.30	0.97	0.65	0.49	0.24			
	9	0	0	(•	0	0	()	100	POP-UP SPRAY HEAD	HUNTER PROS-06-CV-07	30	6' - 7'	1.95	1.46	1.30	0.97	0.65	0.49	0.24			
	•		•	0	0	0	0	(3)	0	POP-UP SPRAY HEAD (STRIP PATTERN)	HUNTER PROS-06-CV- (WITH STRIP NOZZLE) -LCS -RCS -SS	30	5' X 15' 5' X 30'								1.30	0.65	0.65
			0		0	0	0	(3)	0	POP-UP SPRAY HEAD	HUNTER PROS-12-CV-17	30	16' - 17	4.82	3.61	3.21	2.41	1.61	1.20	0.60			
	9	9	0	0	0	0	0	(3)	0	POP-UP SPRAY HEAD	HUNTER PROS-12-CV-15	30	13' - 15	3.71	2.79	2.48	1.86	1.24	0.93	0.46			
	0	0		(0	0	9	0	POP-UP SPRAY HEAD	HUNTER PROS-12-CV-12	30	11' - 12	2.85	2.14	1.90	1.42	0.95	0.71	0.36			
	•	9		0		0	0	3	0	POP-UP SPRAY HEAD	HUNTER PROS-12-CV-10	30	7' – 10'	1.95	1.46	1.30	0.97	0.65	0.49	0.24			
0	9	(9)	0	②	0	0	0	(3)	8	POP-UP SPRAY HEAD	HUNTER PROS-12-CV-07	30	6' - 7'	1.95	1.46	1.30	0.97	0.65	0.49	0.24			
0	9	9	0	O	0	0	0	(3)	8	POP-UP SPRAY HEAD (STRIP PATTERN)	HUNTER PROS-12-CV- (WITH STRIP NOZZLE) -LCS -RCS -SS	30	5' X 15' 5' X 30'								1.30	0.65	0.65
	•	0	0	©	0	0	0	9	0	POP-UP SPRAY HEAD (SHORT RADIUS)	HUNTER PROS-12-CV-07	30	2'				0.16		0.11				
		0	0	O	0	0	0	3	0	POP-UP SPRAY HEAD (SHORT RADIUS)	HUNTER PROS-12-CV-07	30	4'				0.44		0.22				
	9	9		0	•	0	0	(3)	8	POP-UP SPRAY HEAD (SHORT RADIUS)	HUNTER PROS-12-CV-07	30	6'				0.98		0.51				
	9	0	0	O	•	0	0	(3)	100	POP-UP MICRO SPRAY HEAD (SHORT RADIUS)	HUNTER PROS-12-CV- (WITH MICRO SPRAY NOZZLE) -MS-F -MS-H -MS-Q												
	•	0	((•	0	0	9	0	POP-UP STREAM SPRAY HEAD	HUNTER PROS-12-CV-S-16A	30	6'	1.66			0.88		0.50				
	0	0		0	0	0	0	0	0	POP-UP BUBBLER NOZZLE HEAD	HUNTER PCN-10	30	1' - 3'	1.0									
90. PC	360° PC	360° PC	360° PC	360° PC	360° PC	360° PC	360° PC	360° PC	360° PC	DESCRIPTION	MANUFACTURER / MODEL	PSI	RAD.			DIS	CHARG	E (GPN	A)		***************************************		***************************************
		(9)	0	.	(*)		0				HUNTER INDUSTRIES I-20-ADV / 36V -XX (SEE NOTE BELOW FOR ARC AND NOZZLE)	50	31' - 44	,			6.80	5.50	4.20	3.40	2.70	2.00	1.20
						0	0				HUNTER INDUSTRIES I-20-ADV / 36V -LA (SEE NOTE BELOW FOR ARC AND NOZZLE)	50	28' - 37	,						4.40	3.50	2.80	2.10
()		(1)	0	(٥		0				HUNTER INDUSTRIES I—20—ADV / 36V —SR (18' RADIUS) (SEE NOTE BELOW FOR ARC AND NOZZLE)	50	18'								2.00	1.00	0.50
			0				0				HUNTER INDUSTRIES I-20-ADV / 36V -SR (25' RADIUS) (SEE NOTE BELOW FOR ARC AND NOZZLE)	50	25'								3.00	1.50	0.75
		0	9		®	•	0				HUNTER INDUSTRIES I-20-ADV-HP / 36V-HP -XX (SEE NOTE BELOW FOR ARC AND NOZZLE)	50	31' - 44	,			6.80	5.50	4.20	3.40	2.70	2.00	1.20
		(*)	9				•				HUNTER INDUSTRIES 1-20-ADV-HP / 36V-HP -LA (SEE NOTE BELOW FOR ARC AND NOZZLE)	50	28' - 37	3						4.40	3.50	2.80	2.10
	(3)	0	9	٥	0	0	(HUNTER INDUSTRIES I—20—ADV / 36V —SR (18' RADIUS) (SEE NOTE BELOW FOR ARC AND NOZZLE)	50	18'	***************************************							2.00	1.00	0.50
	9	0	(0				HUNTER INDUSTRIES I—20—ADV / 36V —SR (25' RADIUS) (SEE NOTE BELOW FOR ARC AND NOZZLE)	50	25'								3.00	1.50	0.75
())		0	9	(O	0	0				HUNTER INDUSTRIES I—10—ADV / 36V —XX (SEE NOTE BELOW FOR ARC AND NOZZLE)	50	31' - 44	,			6.80	5.50	4.20	3.40	2.70	2.00	1.20
		(9)	(9)		®						HUNTER INDUSTRIES I—10—ADV / 36V —LA (SEE NOTE BELOW FOR ARC AND NOZZLE)	50	28' - 37	,						4.40	3.50	2.80	2.10
))	1					T						50	18'								^ ^ ^	7	0.50
	(5)						0				HUNTER INDUSTRIES I-10-ADV / 36V -SR (18' RADIUS) (SEE NOTE BELOW FOR ARC AND NOZZLE)	อบ	10								2.00	1.00	10.50

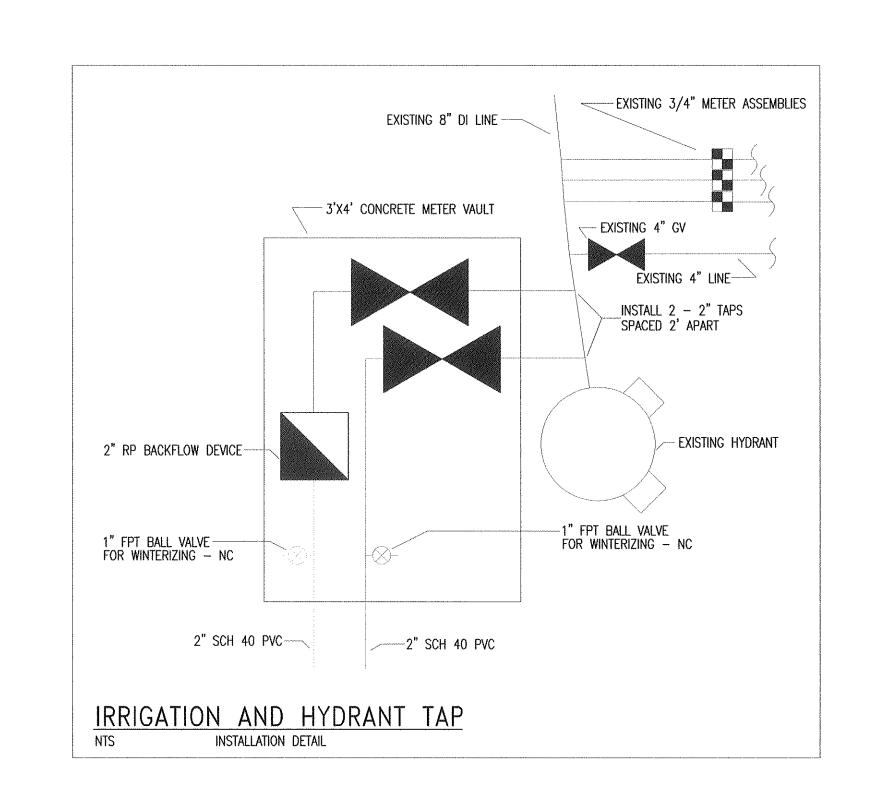







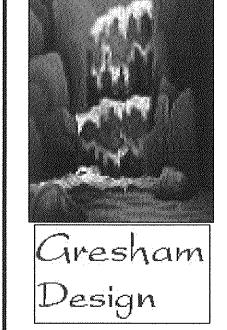


1941 Lake Whatcom Blvd. Bellingham, WA 98229 (360) 756-0996 Gresham-Design.com

Sheet Title: Irrigation Details

Sheet Number:

03-07 Preliminary Submittal

Design and Drawing: BLG

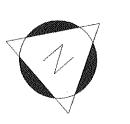

NOTE: PIPE LAYOUT ON DRAWING IS FOR CLARITY PURPOSES ONLY, ALL PIPE INSTALLED BELOW CONCRETE SHALL BE CONSOLIDATED TO ONE TRENCH, TRENCH DIMENSIONS SHALL NOT EXCEED 24" WIDTH X 36" DEPTH

