

CITY OF FERNDALE PS #2 & PS #3 Upgrades Project

Issue Date: June 23, 2016

ADDENDUM NO. 2

General: Recitations of each and every section of the bid documents impacted by this addendum are not given. The described changes impact all relevant portions of the bid documents whether specifically cited below or not.

CLARIFICATIONS AND REVISIONS

1. Specification Section 15800 – ROOF EXHAUST FANS AND LOUVERED VENTS

Revise 2.01 A. 3. as follows:

3. Type: Series A87-4-151FE100STFCH3 fiberglass centrifugal exhaust fan, 15-in diameter, full width, 2900 CFM at 0.25" static pressure; equipped with a VFD compatible IEEE841 1-hp, 1750 rpm motor or approved equal. Hand control of fan control via a VFD controller mounted in the Motor Room. Reference the electrical plans and specifications for additional information.

Add 2.02 A. 4. as follows:

4. Insect screen and insulated blank-off panel shall be painted black.

2. Specification Section 16010 – ELECTRICAL GENERAL

The owner-furnished pumps at both PS#2 and PS#3 will be submersible and will each include 100 feet of cable. Core drill through slab to allow passage of pump cables. Provide T316 stainless steel hooks and wire mesh strain relief cable grips for cable support. Provide T316 stainless steel cable tray horizontally on wall to support cables. See drawing detail attached. Route and secure pump cables in cable tray and to pump motors.

Note: Local disconnects at the pumps will not be required. The lockable pump starter/MCC disconnects will serve as the motor disconnecting means per NEC 430.102(B)(2).


3. Detail 2/M1.2 (PS#2) & Detail 2/M1.3 (PS#3) – SUMP PUMP PIPING SCHEMATIC


Replace the detail referenced above with the attached, revised Detail 2/M1.2 (PS#2) and Detail 2/M1.3 (PS#3).

4. General Information – Steel Platforms and Wet Well Ladder


- The checker plate thickness for the generator and propane tank platforms shall be χ'' .
- the two platforms can be supplied with standard single angle connection clips so they can be a "bolted" assembly.
- Replace the "Wet Well Ladder Detail" for both pump stations with the attached detail.


*** END OF ADDENDUM #2***

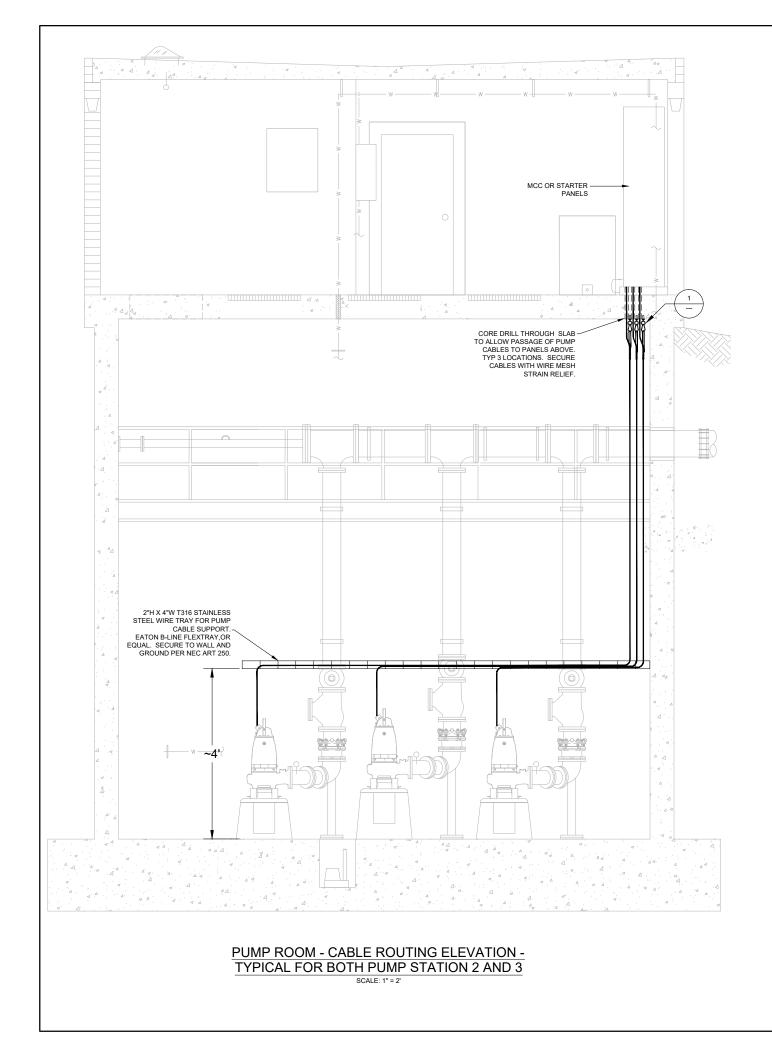

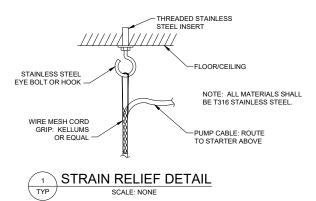

	SURVEY/ENGINERING, LIC SURVEY/ENGINERING, LIC 805 DUPONT STREET 805 DUPONT STREET 80	
	DESIGNED BY BZ	DRAWN BY GH CHECKED BY BZ
	CITY OF FERNDALE	WHATCOM COUNTY PUMP STATION NO.2&3 CABLE ROUTING DETAIL
Zengineers, PLLC One Fith Street, Ske 150 Venether, WA 49801 Www.zengineers.com	DATE 06/22/2016	SCALE AS SHOWN JOB NUMBER 2014–079B
ADDENDUM#2		

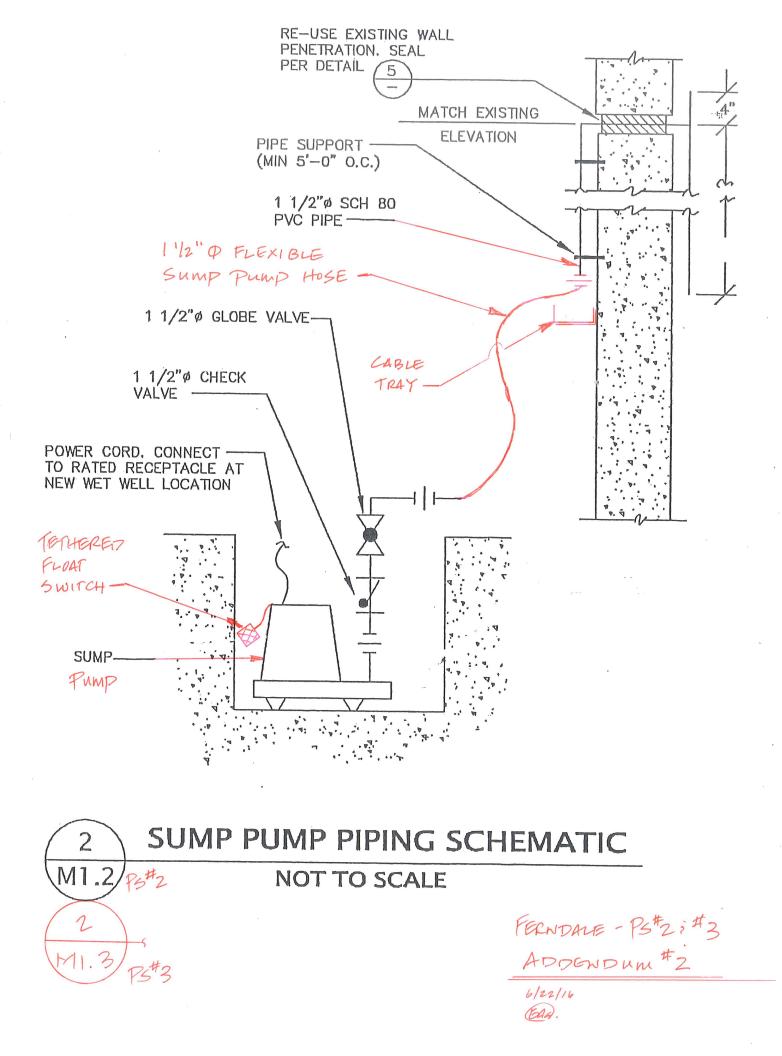

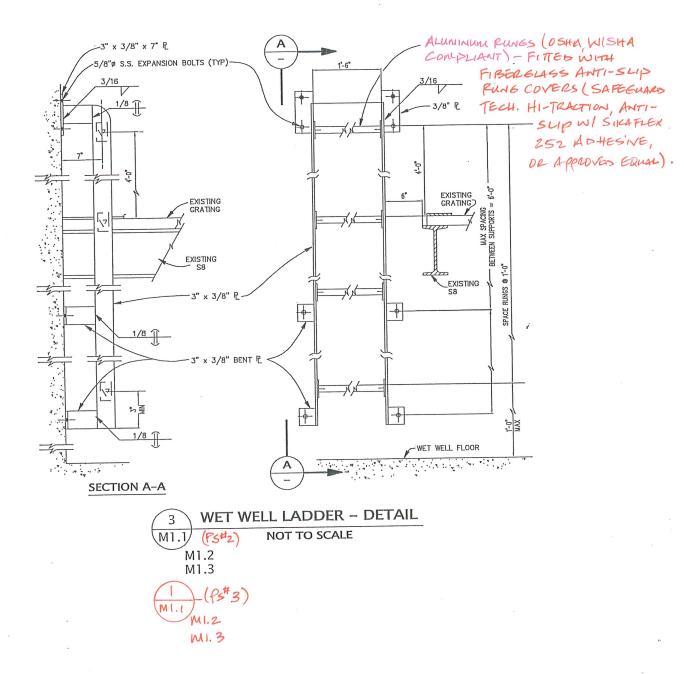

FEENDALE P3#2 3 # 3 AODENDUM # 2 6/22/16 EAG .